SITE PLAN NOTES 1. DEMOLITION CONTRACTOR SHALL RELOCATE REUSABLE MATERIALS TO DESIGNATED SALVAGE AREA. NON-USABLE MATERIALS SHALL BE PLACED APPROPRIATELY IN REFUSE BIN AND SHALL BE COVERED AT NIGHT AND DURING RELATIVE HIGH WINDS. RAIN, ETC...REFUSE BIN SHALL BE COVERED DURING TRANSFER TO AND FROM DUMP SITE. CONTRACTOR TO BE LIABLE FOR REFUSE SPILLING. ALL DEBRIS TO BE HAULED AWAY AND CLEAN-UP SHALL BE COMPLETED TO BROOM FINISH. EXISTING MATERIALS AND/OR STRUCTURE TO REMAIN SHALL BE PROTECTED FROM DUST, PAINT CHIPPING, ETC..., BY USE OF PLASTIC OR WHATEVER IS REQUIRED FOR PROPER PROTECTION. EXISTING STRUCTURES SHALL HAVE BRACING AND SHORING AS REQUIRED TO PROTECT THE EXISTING STRUCTURE. PROVIDE DE-WATERING FACILITIES FOR

2. THE DISCHARGE OF POLLUTANTS TO ANY STORM DRAINAGE SYSTEM IS PROHIBITED. NO SOID WASTE, PETROLEUM BYPRODUCTS, SOIL PARTICULATE, CONSTRUCTION WASTE MATERIALS. OR WASTEWATER GENERATED ON CONSTRUCTION SITES OR BY CONSTRUCTION ACTIVITIES SHALL BE PLACED, CONVEYED OR DISCHARGED INTO THE STREET, GUTTER OR STORM

INFORMATION, STRUCTURAL, ETC. TO DESIGNER/ENGINEER AS

CONSTRUCTION AS REQUIRED. COORDINATE AS-BUILT

3. THE CONSTRUCTION SHALL NOT RESTRICT A FIVE-FOOTCLEAR AND UNOBSTRUCTED ACCESS TO ANY WATER OR POWER DISTRIBUTION FACILITIES (POWER POLES, PULLBOXES, TRANSFORMERS, VAULTS, PUMPS, VALVES, METERS, PPURTENANCES, ETC.) OR TO THE LOCATION OF THE HOOK-UP. THE CONSTRUCTION SHALL NOT BE WITHIN TEN FEET OF ANY POWER LINES WHETHER OR NOT THE LINES ARE LOCATED ON THE PROPERTY. FAILURE TO COMPLY MAY CAUSE CONSTRUCTION DELAYS AND/OR ADDITIONAL EXPENSES.

4. WHEN UTILITIES METER ALTERATION / RELOCATION OCCUR, INSTALLATION PROCEDURES SHALL BE VERIFIED AND APPROVED BY THE BUILDING INSPECTOR PRIOR TO INSTALLATION.

5.THIS IS NOT A SURVEYED PLAN AND ONLY SHOWS DIMENSIONS GIVEN BY HOMEOWNER. PROPERTY MEASUREMENTS SHOULD BE CONFIRMED WITH A LICENSED LAND SURVEYOR IF REQUIRED.

### **VICINITY MAP GENERAL NOTES**

1. THE CONSTRUCTION SHALL NOT RESTRICT A FIVE-FOOT CLEAR AND UNOBSTRUCTED ACCESS TO ANY WATER OR POWER DISTRIBUTION FACILITIES (POWER POLES, PULL-BOXES. TRANSFORMERS, VAULTS, PUMPS, VALVES, METERS, ETC) OR TO THE LOCATION OF THE HOOK-UP. THE CONSTRUCTION SHALL NOT BE WITHIN TEN FEET OF ANY POWER LINES-WHETHER OR NOT THE LINES ARE LOCATED ON THE PROPERTY. FAILURE TO COMPLY MAY CAUSE CONSTRUCTION DELAYS AND/ OR ADDITIONAL EXPENSES.

2. AN APPROVED SEISMIC GAS SHUTOFF VALVE WILL BE INSTALLED ON THE FUEL GAS LINE ON THE DOWN STREAM SIDE OF THE UTILITY METER AND BE RIGIDLY CONNECTED TO THE EXTERIOR OF THE BUILDING OR STRUCTURE CONTAINING THE FUEL GAS PIPING. 3. PROVIDE LOW CONSUMPTION WATER CLOSETS FOR ALL NEW CONSTRUCTION. EXISTING SHOWER HEADS AND TOILETS MUST BE ADAPTED FOR LOW WATER CONSUMPTION. 4. PROVIDE 72" HIGH NON-ABSORBENT WALL ADJACENT TO SHOWER AND APPROVED

SHATTER-RESISTANT MATERIALS FOR SHOWER ENCLOSURE. 5. ALL CONSTRUCTION WASTE AND DEBRIS MUST BE CONTAINERIZED AT ALL TIMES 6. FINAL APPROVAL REQUIRED BY THE PUBLIC WORKS DEPARTMENT FOR STREET IMPROVEMENTS, CURB CORES, CURB/GUTTERS, ETC. SEPARATE PUBLIC WORKS PERMIT REQUIRED FOR DRIVEWAYS, APPROACH TO DRIVEWAY, SEWER LATERALS AND ANY WORK

IN RIGHT OF WAY. 7. ALL CONSTRUCTION SHALL COMPLY WITH ALL APPLICABLE FEDERAL, STATE AND LOCAL CODES AND AMENDMENTS. 8. A SURVEY SHALL BE PROVIDED BY A LICENSED SURVEYOR ON STRUCTURES WHICH DEFINE PROPERTY LINES, SET BACKS, DESIGNATED PARKLAND OR STREET RIGHT-OF-WAY. 9. DUST CONTROL MEASURES SHALL BE MAINTAINED THROUGHOUT THE DURATION OF THE 10. WATER HEATER MUST BE STRAPPED TO WALL.

11. PROVIDE ULTRA FLUSH WATER CLOSETS FOR ALL NEW CONSTRUCTION. EXISTING SHOWER HEADS AND TOILETS MUST BE ADAPTED FOR WATER CONSUMPTION. 12. LAG BOLTS: PROVIDE LEAD HOLE 40%-70% OF THREADED SHANK DIA. AND FULL DIA. FOR SMOOTH SHANK PORTION. 91 NDS 13. BLOCKING. ROOF RAFTERS AND CEILING JOINTS SHALL BE SUPPORTED LATERALLY TO PREVENT ROTATION & LATERAL DISPLACEMENT IN ACCORDANCE w/ THE PROVISIONS OF

14. CONTRACTOR AND/OR OWNER SHALL VERIFY CONSTRUCTION SITE TO CONFIRM THAT

THERE IS NO TRACEOF DEMOLISHED SWIMMING POOL WITHIN 5 FT FROM PROPOSED PERIMETER OF THE CONSTRUCTION SITE. OTHERWISE, THEY NEED TO SUBMIT SOIL COMPACTION REPORT FROM LICENSED SOIL ENGINEER TO BUILDING INSPECTOR PRIOR TO FOUNDATION INSPECTION 15. SHEARWALLS, LATHING & PLASTER IN MATERIALS SHALL CONFORM TO THE STANDARD LISTED IN CH 6 & CH 7 CRC 16. ALL BOLT HOLES SHALL BE DRILLED 1/32" TO 1/16" OVERSIZED. "ENGINEER" MUST INCLUDE IN STRUCTURAL OBSERVATION NOTES.

17. PROVIDE RAIN GUTTERS AND CONVEY RAIN WATER TO THE STREET. 18. CONCRETE 3000PSI

19. PARALLEL BEAM E.2.0 PSL 20. UFER GROUND IS REQUIRED AT NEW ELECTRICAL SERVICE.

21. UNDERGROUND UTILITIES REQUIRED ON SITE PLAN AND SHOW FOR ELECTRICAL, CABLE TV. AND

22. ARC FAULT CIRCUIT INTERRUPTION PROTECTION IS REQUIRED FOR ALL BRANCH CIRCUITS PER 2022 CEC210.12 SHALL BE AFCI PROTECTED 23. BATHROOMS, KITCHEN, GARAGE & OUTSIDE OUTLETS WILL BE GFCI PROTECTED RECEPTACLE OUTLETS. 24. WATER SAVING WATER CLOSET w/1.28 GALLONS PER FLUSH. 25. PROVIDE MECHANICAL VENTILATION FOR BATHROOMS AND LAUNDRY ROOMS WITHOUT OPENABLE

26. GLAZING WHICH IS LESS THAN 60 INCHES FROM A FLOOR AND WITHIN A 24" ARC OF A DOORWAY'S VERTICAL EDGE MUST COMPLY WITH CH.3 CRC 27. LANDINGS AT DOOR. LANDINGS SHALL HAVE A WIDTH NOT LESS THAN THE WIDTH OF THE STAIRWAY OR THE DOOR. WHICHEVER IS GREATER.

28. EVERY SPACE INTENDED FOR HUMAN OCCUPANCY SHALL BE PROVIDED WITH A NATURAL LIGHT IN ACCORDANCE WITH CRC R303.1(2022) OR SHALL BE PROVIDE AN AVERAGE ILLUMINATION OF 6 FEET-CANDLES OVER THE AREA OF THE ROOM AT A HEIGHT OF 30" ABOVE THE FLOOR LEVEL. 29. THE CONTRACTOR SHALL EXAMINE AND BECOME FAMILIAR WITH ALL CONTRACT DOCUMENTS. SURVEY THE PROPERTY AND BECOME FAMILIAR WITH THE EXISTING CONDITIONS AND SCOPE OF WORK. ALL COST SUBMITTED SHALL BE BASED ON A THROUGH KNOWLEDGE OF ALL WORK AND MATERIALS REQUIRED. ANY DISCREPANCY AND/OR UNCERTAINTY AS TO WHAT MATERIALS OR PRODUCT IS TO BE USED SHOULD BE

VERIFIED WITH THE OWNER OR ENGINEER OF RECORD. 30. DO NOT SCALE DRAWINGS. WRITTEN DIMENSIONS TAKE PRECEDENCE OVER SCALE. 31. IN THE EVENT A DISCREPANCY IS FOUND IN THE CONTRACT DOCUMENTS, THE OWNER AND THE DESIGNER/ENGINEERS SHALL BE NOTIFIED, IN WRITING, IMMEDIATELY. 32. FIRE SPRINKLER SYSTEM SHALL BE APPROVED BY OCFA AND AN APPROVED PLANS SHALL BE INCLUDED IN

DIVISION PRIOR TO ROOF SHEATHING INSPECTION.

THE CONSTRUCTION PACKAGE PRIOR TO BUILDING PERMIT ISSUANCE. 33. VERIFY WITH AQMD FOR ASBESTOS REMOVAL PROCEDURE AND SUBMIT ASBESTOS REPORT TO BUILDING DIVISION PRIOR TO DEMOLITION PERMIT ISSUANCE. 34. TRUSS PACKAGE WITH AN APPROVED STAMP FROM THE ENGINEER OF RECORD SHALL BE SUBMITTED TO THE CITY FOR APPROVAL PRIOR TO BUILDING PERMIT ISSUANCE. 35. LINE AND GRADE CERTIFICATE SHALL BE SUBMITTED TO THE BUILDING INSPECTOR PRIOR TO FOUNDATION

36. SOIL COMPACTION REPORT IS REQUIRED FOR ALL NEW SFD HOUSE OR ADU AT THE TIME OF FOUNDATION 37. WHEN SOLAR PANEL IS REQUIRED, SOLAR PLANS SHALL BE REVIEWED AND APPROVED BY BUILDING

### PROJECT DATA SHEET INDEX

**JURISDICTION HAVING AUTHORITY:** TRACK 2750, LOT 23 066-2750-023

**CONSTRUCTION TYPE:** R-1 RESIDENTIAL **OCCUPANCY GROUP:** NUMBER OF STORIES: 1 STORY, (NO CHANGE) 14FT 6IN,(NO CHANGE) **BUILDING MAX HEIGHT** REQUIRED SETBACKS:

1,500 SF

1500/3600=41.7%, OK

SETBACKS INDICATE REQUIRED MINIMUM DISTANCE FROM PROPERTY LINES. CONTRACTOR TO VERIFY ON SITE.

LOT SIZE : 3,600 SF

**EXISTING:** 

**OVERALL LOT COVERAGE:** 

LEGAL DESCRIPTION:

SPRINKLERS:

ASSESSORS PARCEL NO. APN:

(E) MAIN HOUSE LIVING AREA 1,192 SF (E) GARAGE AREA 196 SF 96 SF (E)SHED **EXISTING TOTAL:** 1,484 SF NEW ADDITION AREA: 16 SF **NEW TOTAL:** 

**MAXIMUM LOT COVERAGE:** 

**MAXIMUM FLOOR RATIO(FAR): OVERALL FLOOR RATIO (FAR):** (1500-196)/3600=36.2%, OK

### SCOPE OF WORK

A.00 COVER PAGE & SITE PLAN

A.11 WINDOW PLAN

A.20 (E)&(P)ROOF PLANS

A.30 (E) ELEVATIONS
A.31 (P) ELEVATIONS

A.32 (E) & (P) SECTIONS

A.33 STREET ELEVATIONS

AD.10 ARCHITECTURAL DETAILS

A.10 EXISTING & PROPOSED PLAN

A.12 LOT COVERAGE & FAR DIAGRAM

A.13 (P)KITCHEN LAYOUT & ELEVATIONS

A.14 (P)KITCHEN LAYOUT & ELEVATIONS

REMOVE THREE BEAMS. -REPLACE THE KITCHEN WOODEN FLOOR AND ADD A COVER IN THE REST OF THE HOUSE FLOOR -ADDITION(16 SF) IN THE KITCHEN. -THE KITCHEN ENTRANCE DOOR DIRECTION WILL BE

-KITCHEN WINDOW AT THE ENTRANCE WILL BE SEALED. -RENOVATION OF THE BATH2 -REPLACE THE PRIMARY BEDROOM WINDOW WITH A DOOR. -WIDEN ENTRANCE FOR NEW FRONT DOOR.

### PROJECT INFORMATION APPLICABLE CODE

OWNER: CREEKSIDE PRO CONSTRUCTION PHONE: (408) 314-4308 (408) 314-4373 EMAIL: Creekinvoice@gmail.com

DESIGNER LEI ZHENG COMPANY: **CECILIA HOME** PHONE: (510) 909-1933 ENGINEER.LEI@GMAIL.COM EMAIL:

PROFESSIONAL ENGINEER: LEI ZHENG COMPANY: CECILIA HOME PHONE: (510) 909-1933 ENGINEER.LEI@GMAIL.COM **LEGAL JURISDICTION: CITY OF ALBANY, CA** THIS PROJECT SHALL COMPLY WITH THE FOLLOWING CODES: 2022 CALIFORNIA RESIDENTIAL CODE 2022 CALIFORNIA PLUMBING CODE 2022 CALIFORNIA MECHANICAL CODE 2022 CALIFORNIA ENERGY CODE 2022 CALIFORNIA ELECTRICAL CODE 2022 CALIFORNIA GREEN BUILDING STANDARDS

1 LANDSCAPE

3 (E) GAS METER

2 (E) TREE

4 (E) GATE


5 WALKWAY

7 (E) CURB

8 (E) BUSHES REMOVED

REGULATION OF THE STATE AND LOCAL FIRE MARSHALS & CITY ORDINANCE CITY OF ALBANY MUNICIPAL CODE.

### SITE PLAN KEYNOTES SYMBOL LEGEND

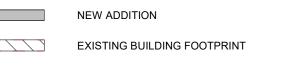

**LEGEND** 


**EXISTING CONSTRUCTION EXISTING CONSTRUCTION** 

**NEW CONSTRUCTION** 

9 ROOF LINE ABOVE

### PARCEL MAP

For Assessment Use Only

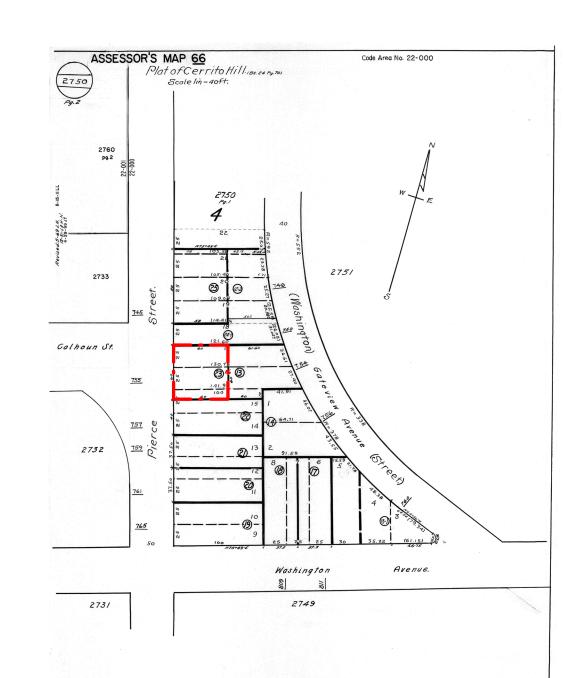

Jurisdiction:

DESCRIPTION

APPLY FOR PERMITS

1ST PLAN CHECK

DATE

04/20/24

05/21/24

CHIEF ENGINEER:LEI ZHENG (MASON)

DURING CONSTRUCTION IF ANY DIFFICULTY

CONTRACTOR WILL TAKE ALL THE LIABILITY

EMAIL: ENGINEER.LEI@GMAIL.COM

OCCUR. PLEASE CONTACT ENGINEER

FROM THE DRAWING WITHOUT PRIOR

APPROVAL FROM ENGINEER, THE

DUE TO DEVIATION.

IMMEDIATELY .IF CONTRACTOR DEVIATE

PHONE: (510)909-1933




SHEET TITLE:

COVER PAGE & SITE PLAN

SHEET NUMBER: A.00



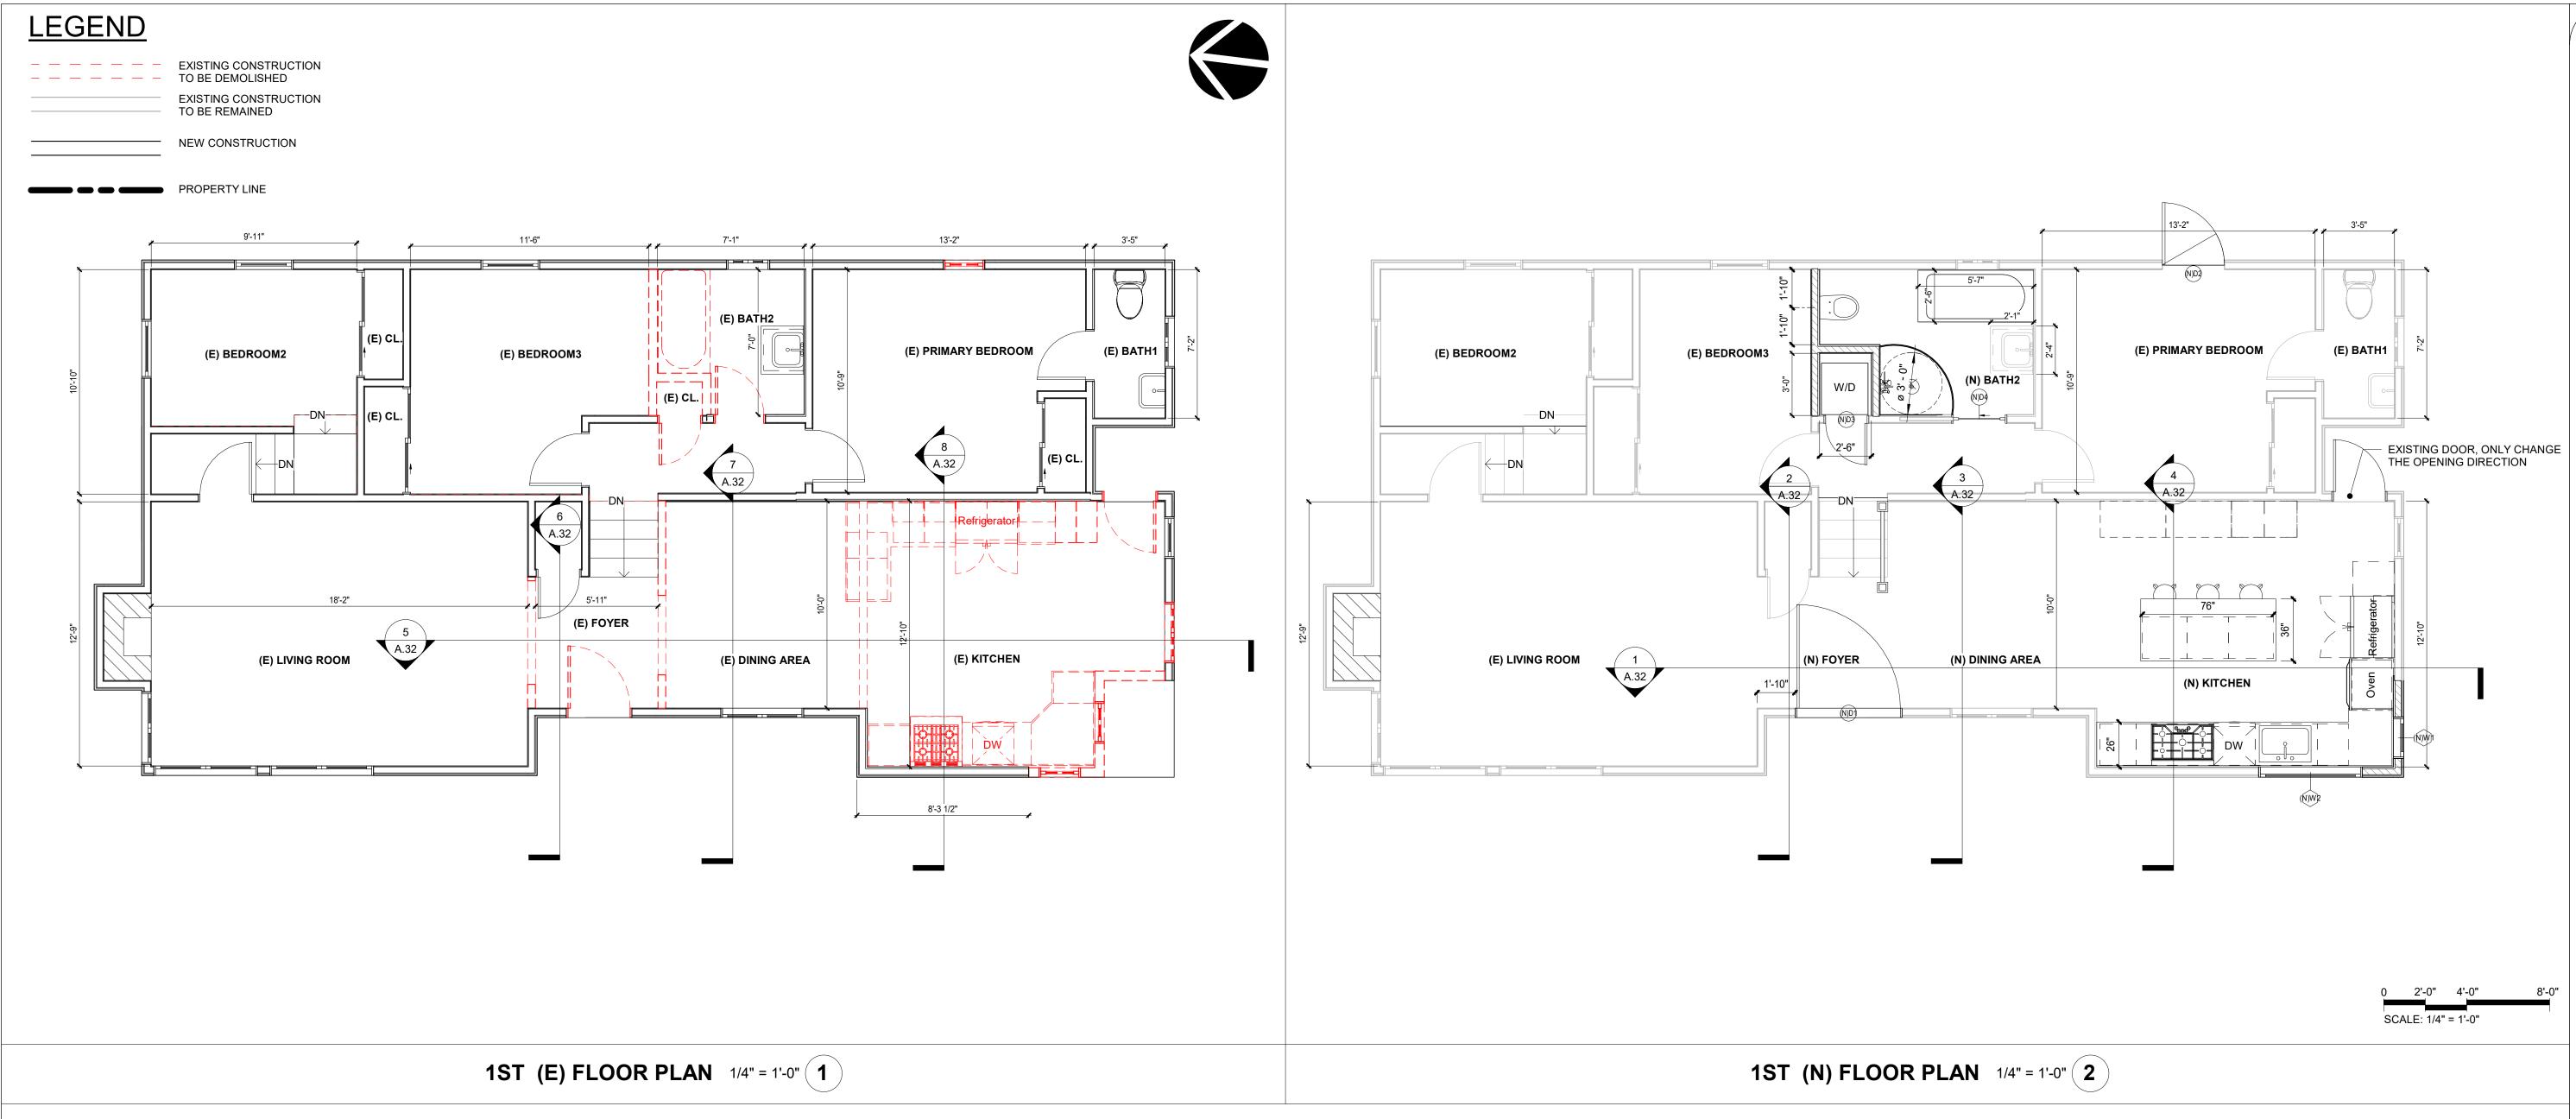




EMAIL: ENGINEER.LEI@GMAIL.COM DURING CONSTRUCTION IF ANY DIFFICULTY OCCUR, PLEASE CONTACT ENGINEER IMMEDIATELY .IF CONTRACTOR DEVIATE
FROM THE DRAWING WITHOUT PRIOR
APPROVAL FROM ENGINEER, THE

CONTRACTOR WILL TAKE ALL THE LIABILITY DUE TO DEVIATION.

	REV.	DESCRIPTION	DATE
	0	APPLY FOR PERMITS	04/20/24
	1	1ST PLAN CHECK	05/21/24


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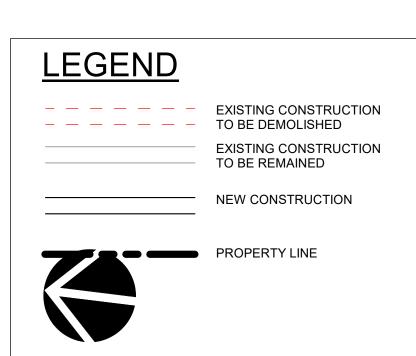


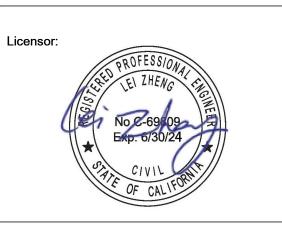
SHEET TITLE:

**EXISTING &** PROPOSED PLAN

SHEET NUMBER:



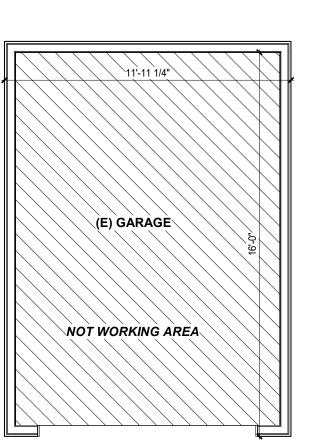

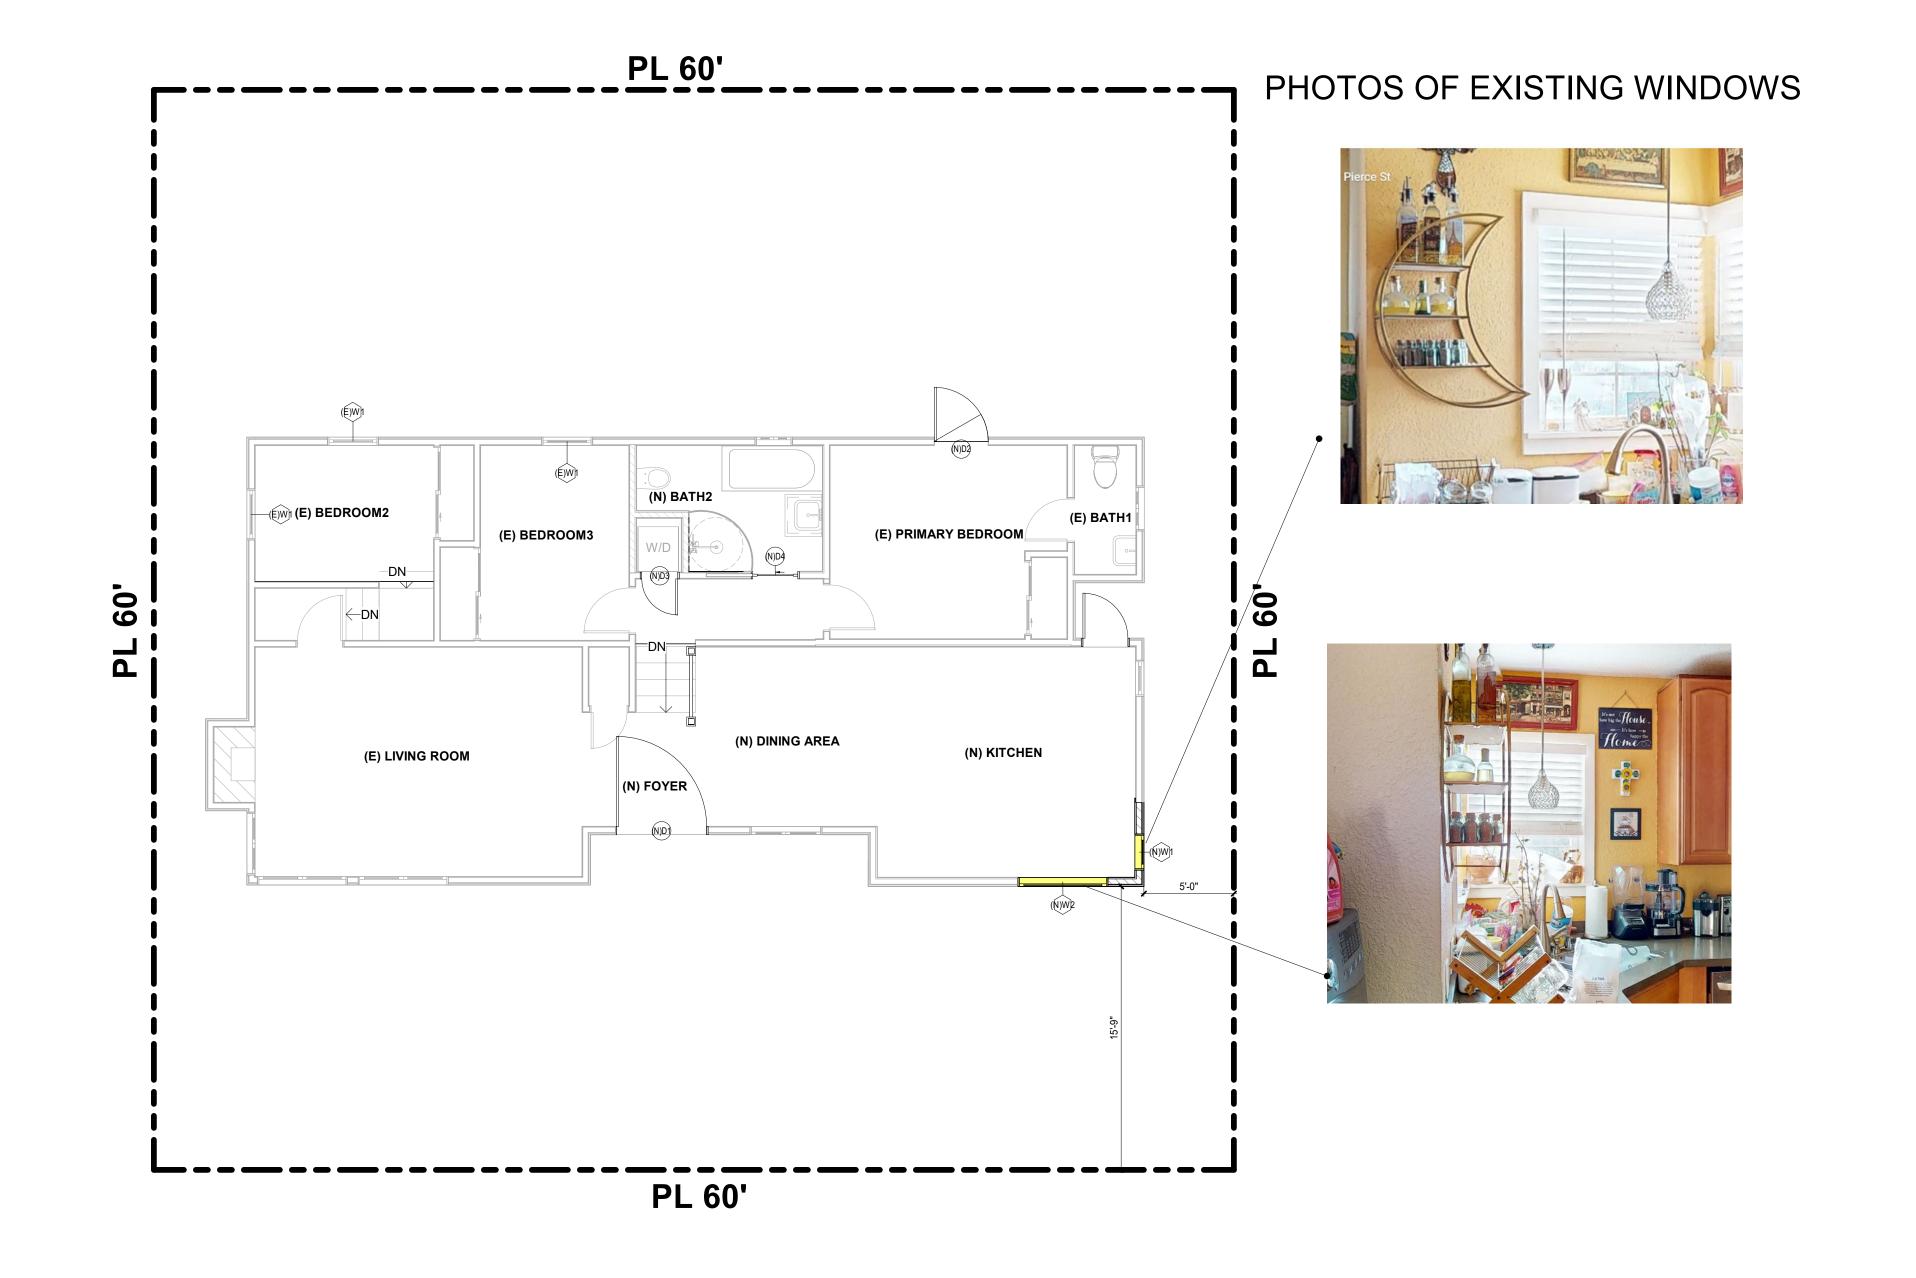


NUMBER DOOR SIZE QTY

DESCRIPTION

5' - 0" x 6' - 8" 1 EXTERIOR DOOR 1 PANEL/TEMPERED GLASS, ALUMINUM FRAME, PAINTED FINISH

(N)D2 3' - 0" x 6' - 8" 1 FRENCH DOOR 1-PANEL SWING/GLASS, WOOD FRAME, PAINTED FINISH

(N)D3 2' - 0" x 6' - 8" 1 SOLID CORE 1 PANEL, WOOD FRAME, PAINTED FINISH
(N)D4 2' - 6" x 6' - 8" 1 POCKET DOOR, SOLID CORE, WOOD FRAME, PAINTED FINISH
Grand total: 4

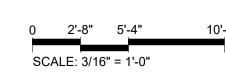

### **WINDOWS PLAN** 3/16" = 1'-0" **1**

QTY	WINDOW SIZE	DESCRIPTION	U-FACTOR	Sill Height	Finish	Glazing	Frame
3	2' - 10" x 3' - 10"	DOUBLE HUNG, DUAL GLASS/ FIBERGLASS FRAME, SOLID CORE, FIBERGLASS FRAME, FINISH PER MFGR.	0.3	2' - 6"	BRUSHED ALUM.	DOUBLE LOW-E	ALUM.
1	2' - 0" x 4' - 0"	FIX WINDOW, DUAL GLASS/ FIBERGLASS FRAME, SOLID CORE, FINISH PER MFGR.	0.3	3' - 0"	WHITE BRUSHED ALUM.	DOUBLE LOW-E	ALUM.
1	5' - 0" x 4' - 0"	FIX WINDOW, DUAL GLASS/ FIBERGLASS FRAME, SOLID CORE, FINISH PER MFGR.	0.3	3' - 6"	WHITE BRUSHED ALUM.	DOUBLE LOW-E	ALUM.
		3 2' - 10" x 3' - 10" 1 2' - 0" x 4' - 0"	2' - 10" x 3' - 10"  DOUBLE HUNG, DUAL GLASS/ FIBERGLASS FRAME, SOLID CORE, FIBERGLASS FRAME, FINISH PER MFGR.  FIX WINDOW, DUAL GLASS/ FIBERGLASS FRAME, SOLID CORE, FINISH PER MFGR.  FIX WINDOW, DUAL GLASS/ FIBERGLASS FRAME, SOLID	2' - 10" x 3' - 10"  DOUBLE HUNG, DUAL GLASS/ FIBERGLASS FRAME, SOLID CORE, FIBERGLASS FRAME, FINISH PER MFGR.  FIX WINDOW, DUAL GLASS/ FIBERGLASS FRAME, SOLID CORE, FINISH PER MFGR.  FIX WINDOW, DUAL GLASS/ FIBERGLASS FRAME, SOLID 0.3	3 2' - 10" x 3' - 10" DOUBLE HUNG, DUAL GLASS/ FIBERGLASS FRAME, SOLID CORE, FIBERGLASS FRAME, FINISH PER MFGR.  1 2' - 0" x 4' - 0" FIX WINDOW, DUAL GLASS/ FIBERGLASS FRAME, SOLID CORE, FINISH PER MFGR.  FIX WINDOW, DUAL GLASS/ FIBERGLASS FRAME, SOLID 0.3 3' - 6"	3 2' - 10" x 3' - 10" DOUBLE HUNG, DUAL GLASS/ FIBERGLASS FRAME, SOLID CORE, FIBERGLASS FRAME, FINISH PER MFGR.  1 2' - 0" x 4' - 0" FIX WINDOW, DUAL GLASS/ FIBERGLASS FRAME, SOLID CORE, FINISH PER MFGR.  5' - 0" x 4' - 0" FIX WINDOW, DUAL GLASS/ FIBERGLASS FRAME, SOLID ALUM.  FIX WINDOW, DUAL GLASS/ FIBERGLASS FRAME, SOLID CORE, FINISH PER MFGR.  1 5' - 0" x 4' - 0" WHITE BRUSHED	3 2' - 10" x 3' - 10" DOUBLE HUNG, DUAL GLASS/ FIBERGLASS FRAME, SOLID CORE, FIBERGLASS FRAME, FINISH PER MFGR.  1 2' - 0" x 4' - 0" FIX WINDOW, DUAL GLASS/ FIBERGLASS FRAME, SOLID CORE, FINISH PER MFGR.  5' - 0" x 4' - 0" FIX WINDOW, DUAL GLASS/ FIBERGLASS FRAME, SOLID CORE, FINISH PER MFGR.  FIX WINDOW, DUAL GLASS/ FIBERGLASS FRAME, SOLID CORE, FINISH PER MFGR.  5' - 0" x 4' - 0" WHITE DOUBLE CORE, FINISH PER MFGR.

2'-0"	3:-0"	2'-10"	5'-0" 1'-0" 3'-0" 1'-0"	3'-0"	2'-2"	2'-6"
(N)W1	(N)W2	(E)W1	(N)D1	(N)D2	(N)D3	(N)D4



WWW.CECILIA123.COM CHIEF ENGINEER:LEI ZHENG (MASON) PHONE: (510)909-1933 EMAIL: ENGINEER.LEI@GMAIL.COM

DURING CONSTRUCTION IF ANY DIFFICULTY OCCUR, PLEASE CONTACT ENGINEER IMMEDIATELY .IF CONTRACTOR DEVIATE FROM THE DRAWING WITHOUT PRIOR APPROVAL FROM ENGINEER, THE CONTRACTOR WILL TAKE ALL THE LIABILITY DUE TO DEVIATION.

### 755 PIERCE ST, BANY, CA 94706

	REV.	DESCRIPTION	DATE
	0	APPLY FOR PERMITS	04/20/24
	1	1ST PLAN CHECK	05/21/24
-8"			
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Jurisdiction:




SHEET TITLE:

WINDOW PLAN

SHEET NUMBER:



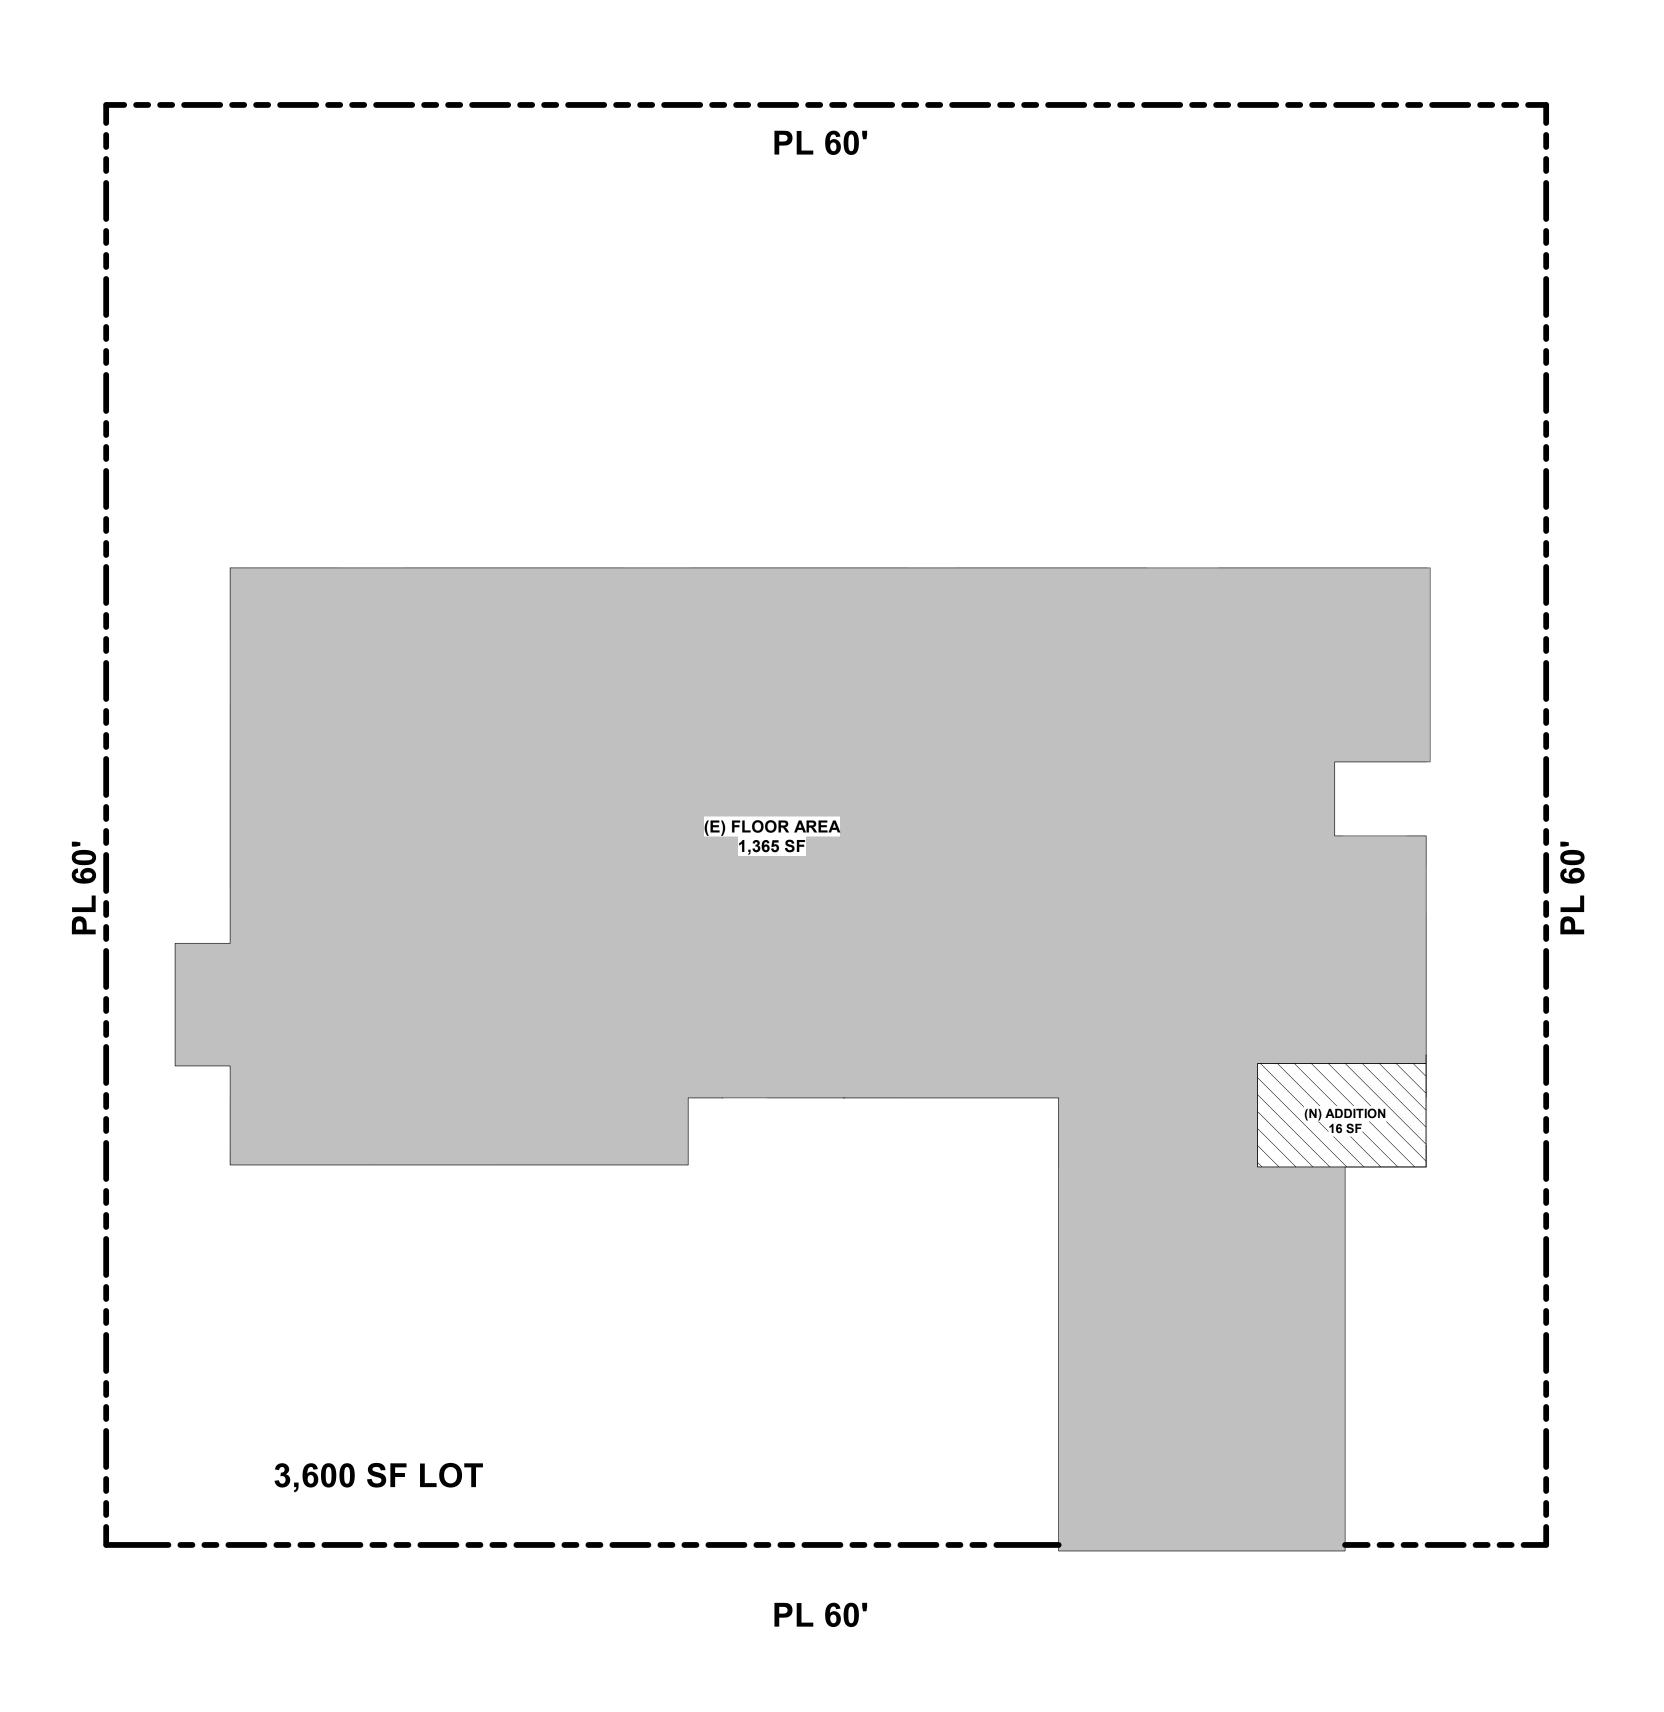

EXISTING: (E) MAIN HOUSE LIVING AREA (E) GARAGE AREA

**EXISTING TOTAL:** 1,388 SF NEW ADDITION AREA: **NEW TOTAL:** MAXIMUM LOT COVERAGE: OVERALL LOT COVERAGE:

55% 1404/3600=39% , OK OVERALL FLOOR RATIO (FAR):

1,192 SF 196 SF

<u>LEGEND</u>

NEW CONSTRUCTION

EXISTING BUILDING FOOTPRINT

0 2'-0" 4'-0" SCALE: 1/4" = 1'-0"

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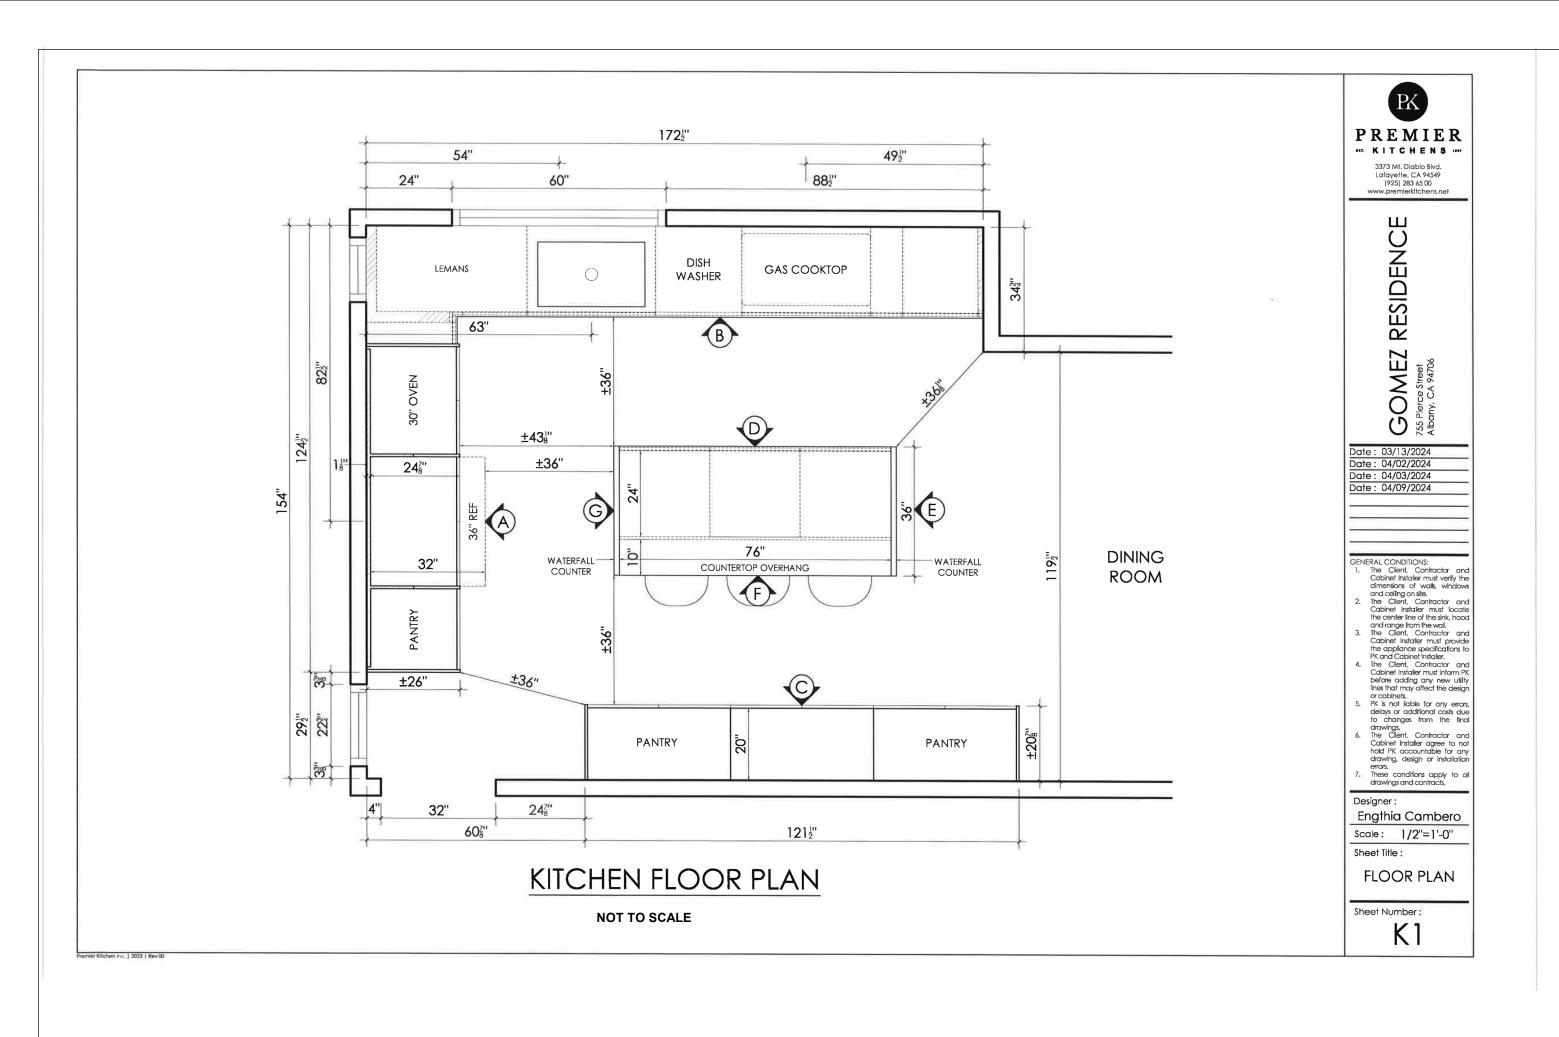
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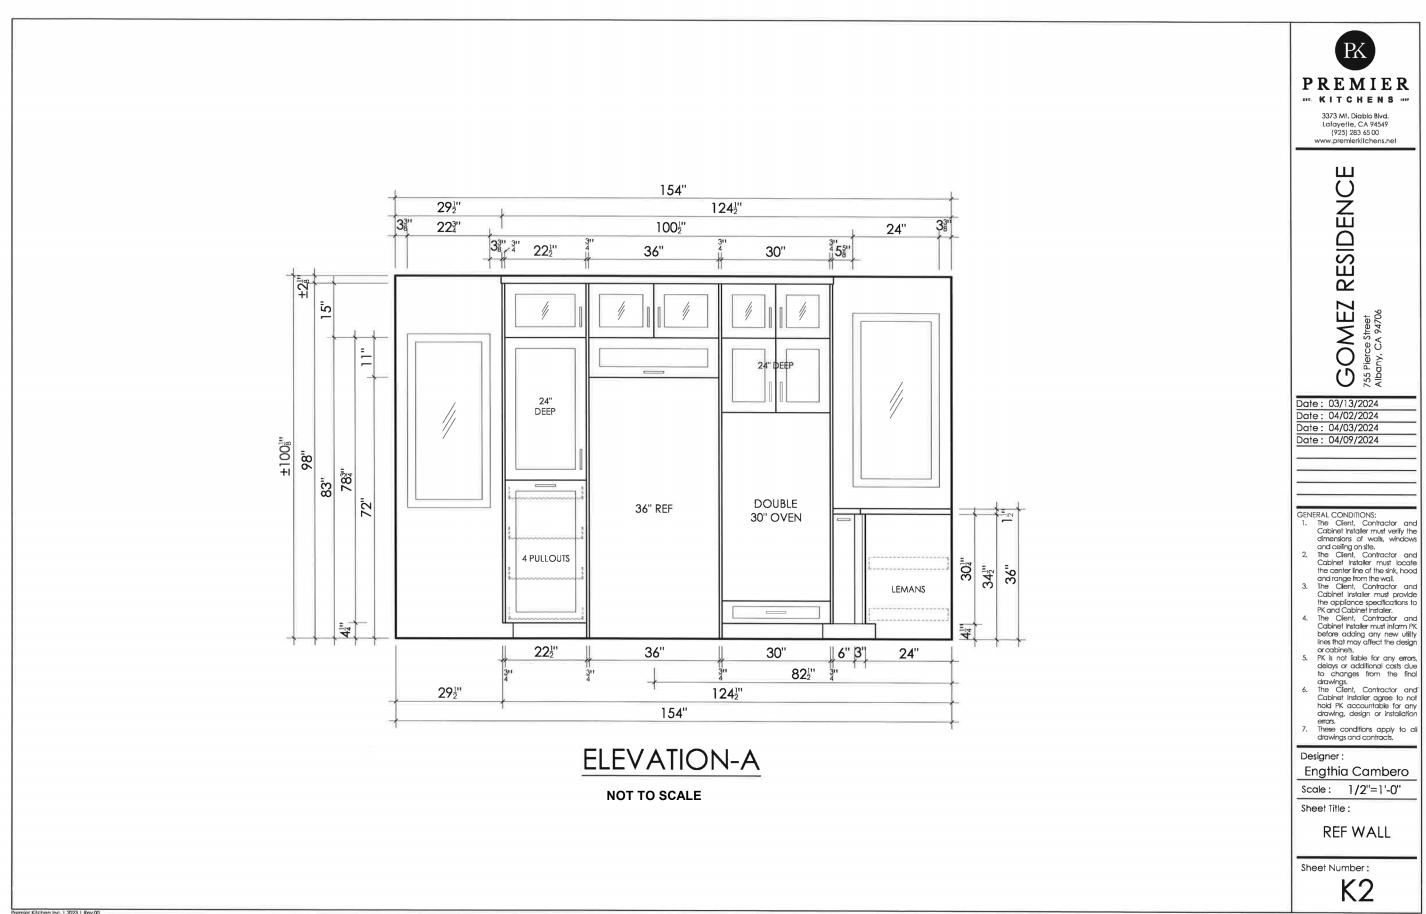



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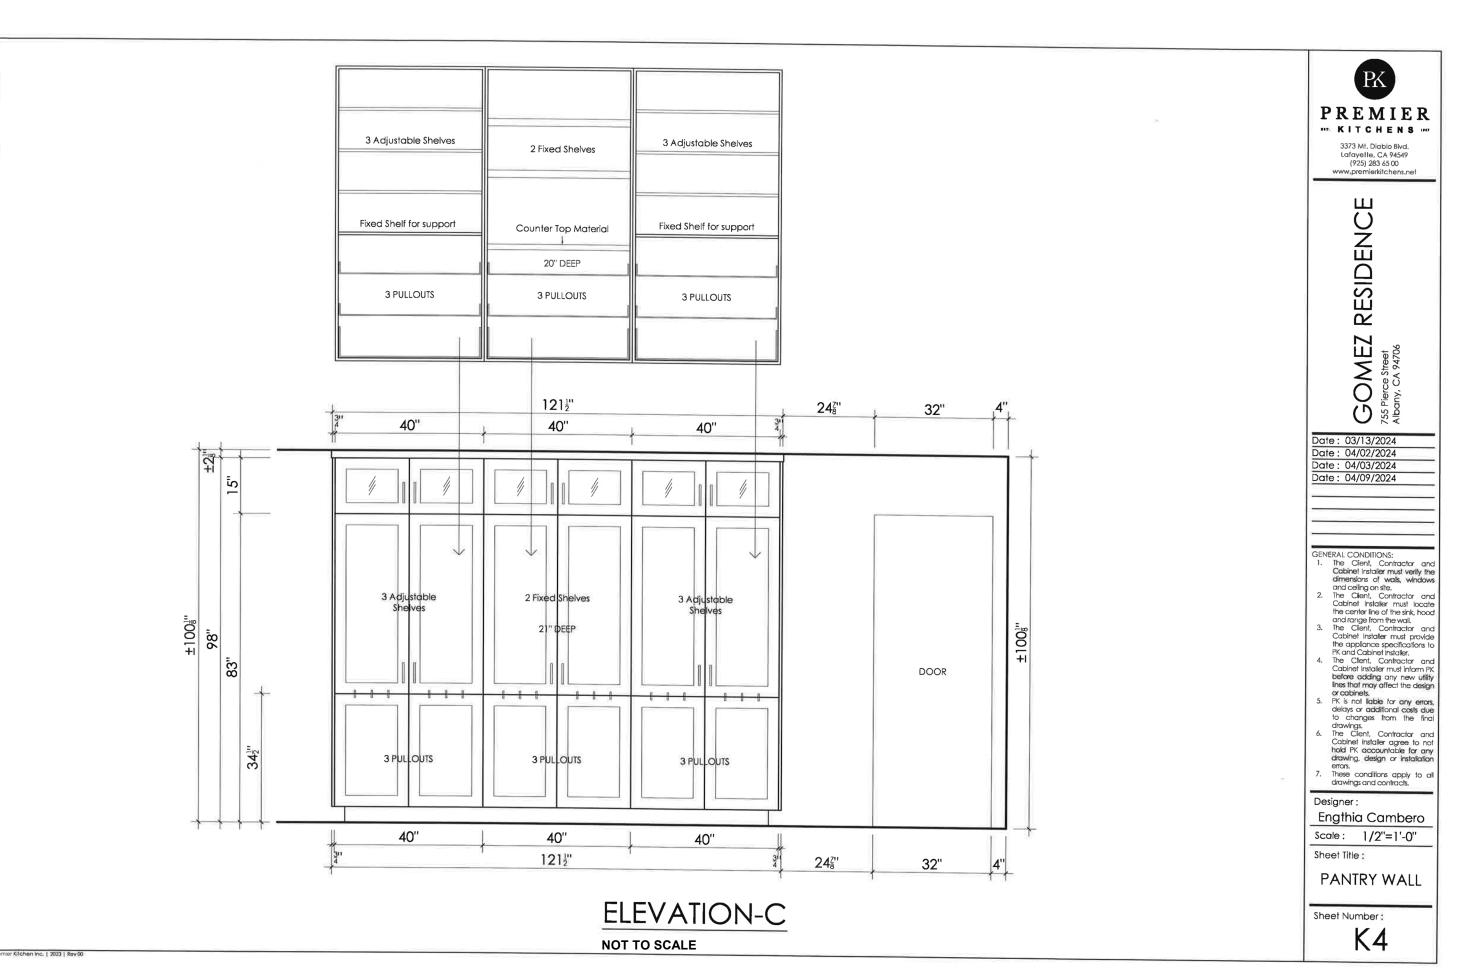
LOT COVERAGE & FAR DIAGRAM

SHEET NUMBER:







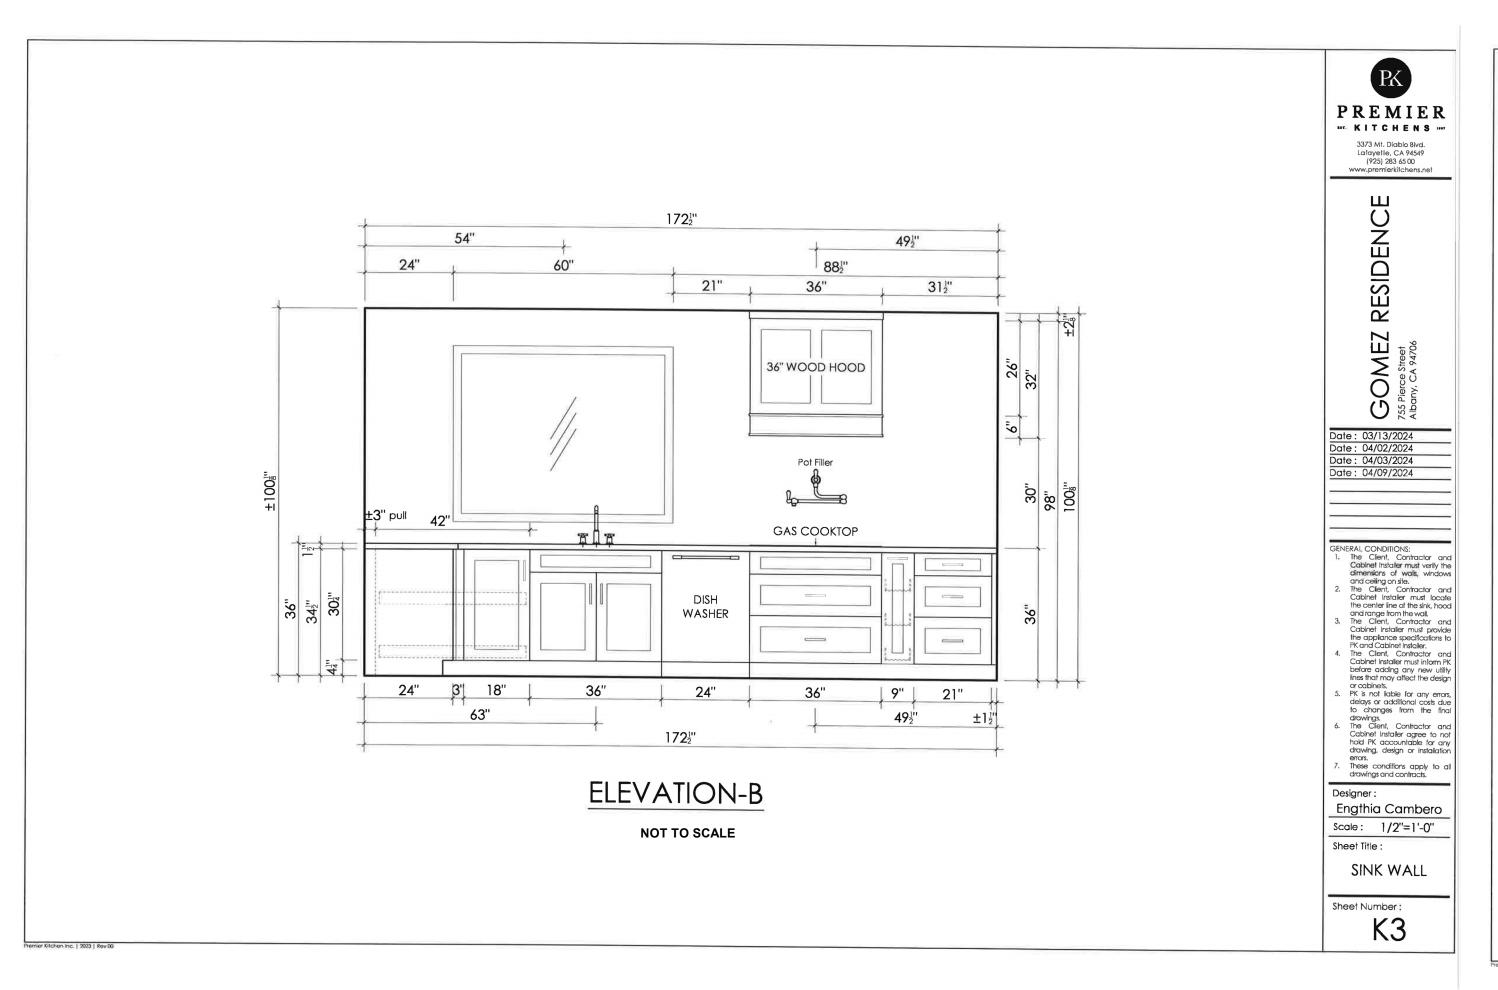



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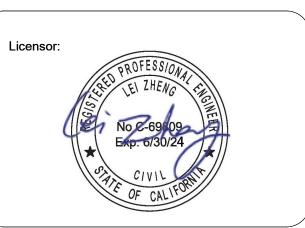
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APPROVAL FROM ENGINEER, THE CONTRACTOR WILL TAKE ALL THE LIABILITY DUE TO DEVIATION.

### 755 PIERCE ST ALBANY, CA 947

	REV.	DESCRIPTION	DATE
	0	APPLY FOR PERMITS	04/20/24
	1	1ST PLAN CHECK	05/21/24


Jurisdiction:



SHEET TITLE:

(P)KITCHEN
LAYOUT &
-ELEVATIONS-

SHEET NUMBER:

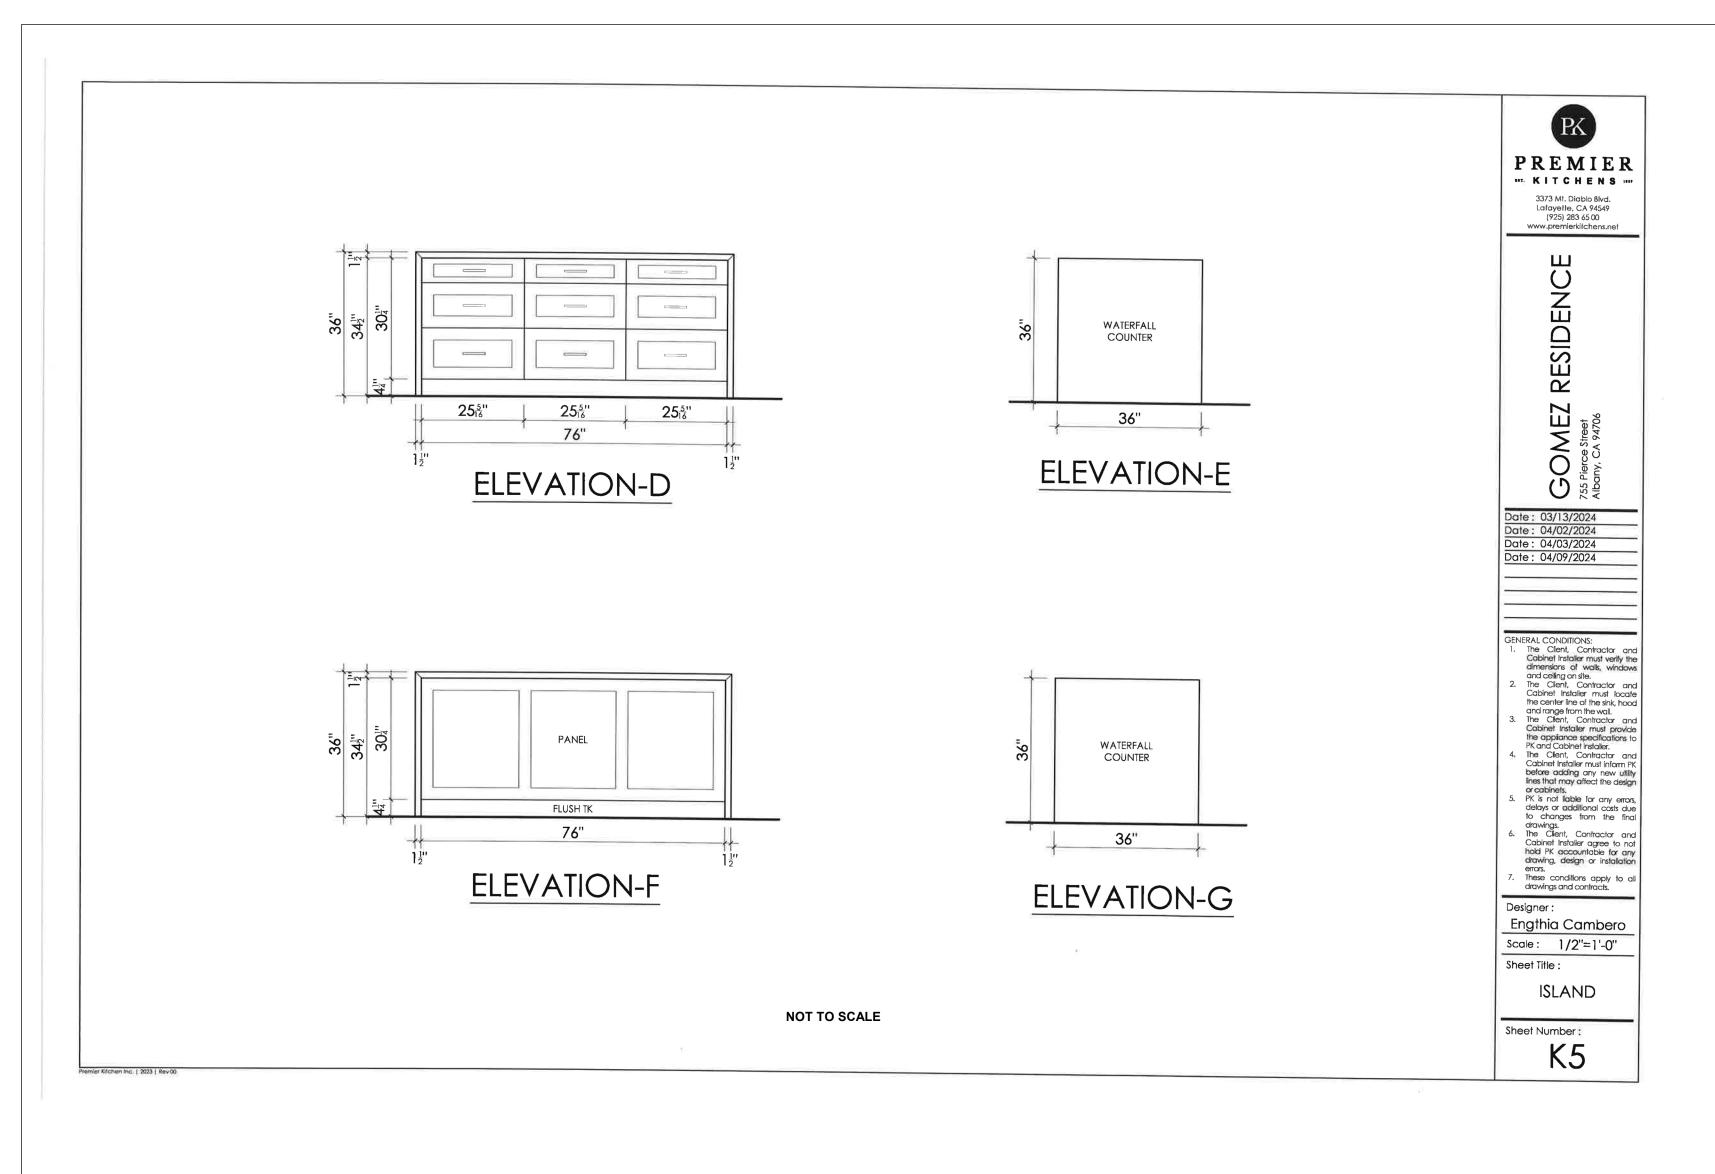



DURING CONSTRUCTION IF ANY DIFFICULTY OCCUR, PLEASE CONTACT ENGINEER IMMEDIATELY .IF CONTRACTOR DEVIATE FROM THE DRAWING WITHOUT PRIOR APPROVAL FROM ENGINEER, THE


EMAIL: ENGINEER.LEI@GMAIL.COM

CONTRACTOR WILL TAKE ALL THE LIABILITY DUE TO DEVIATION.

# 5

	REV.	DESCRIPTION	DATE
	0	APPLY FOR PERMITS	04/20/24
	1	1ST PLAN CHECK	05/21/24

Jurisdiction:

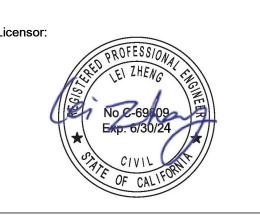


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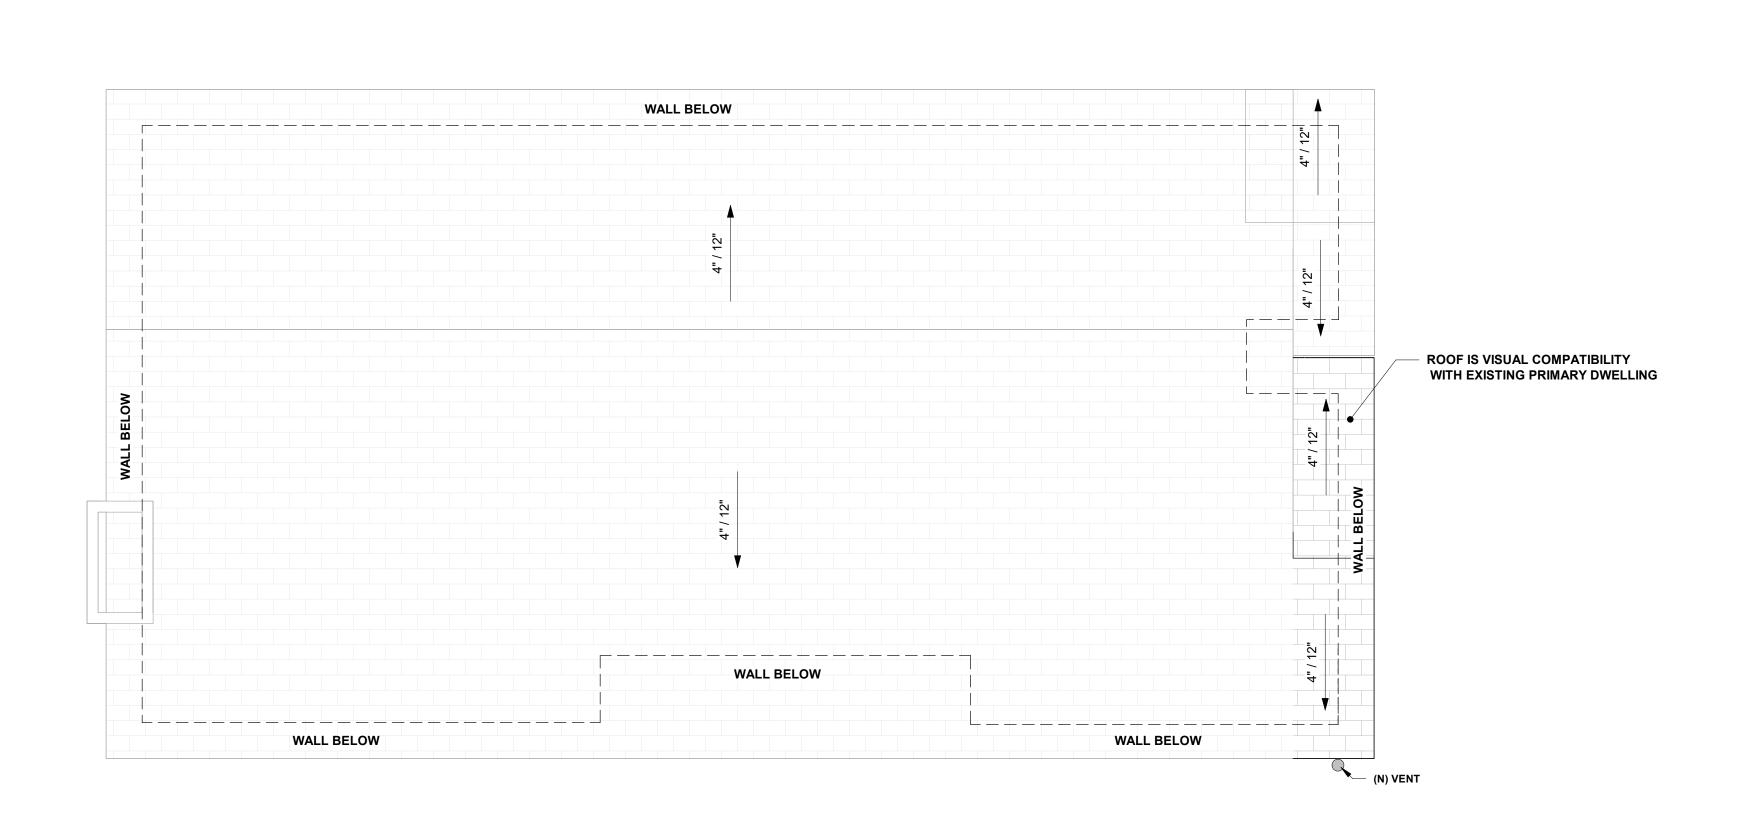
(P)KITCHEN LAYOUT & —ELEVATIONS-

SHEET NUMBER:





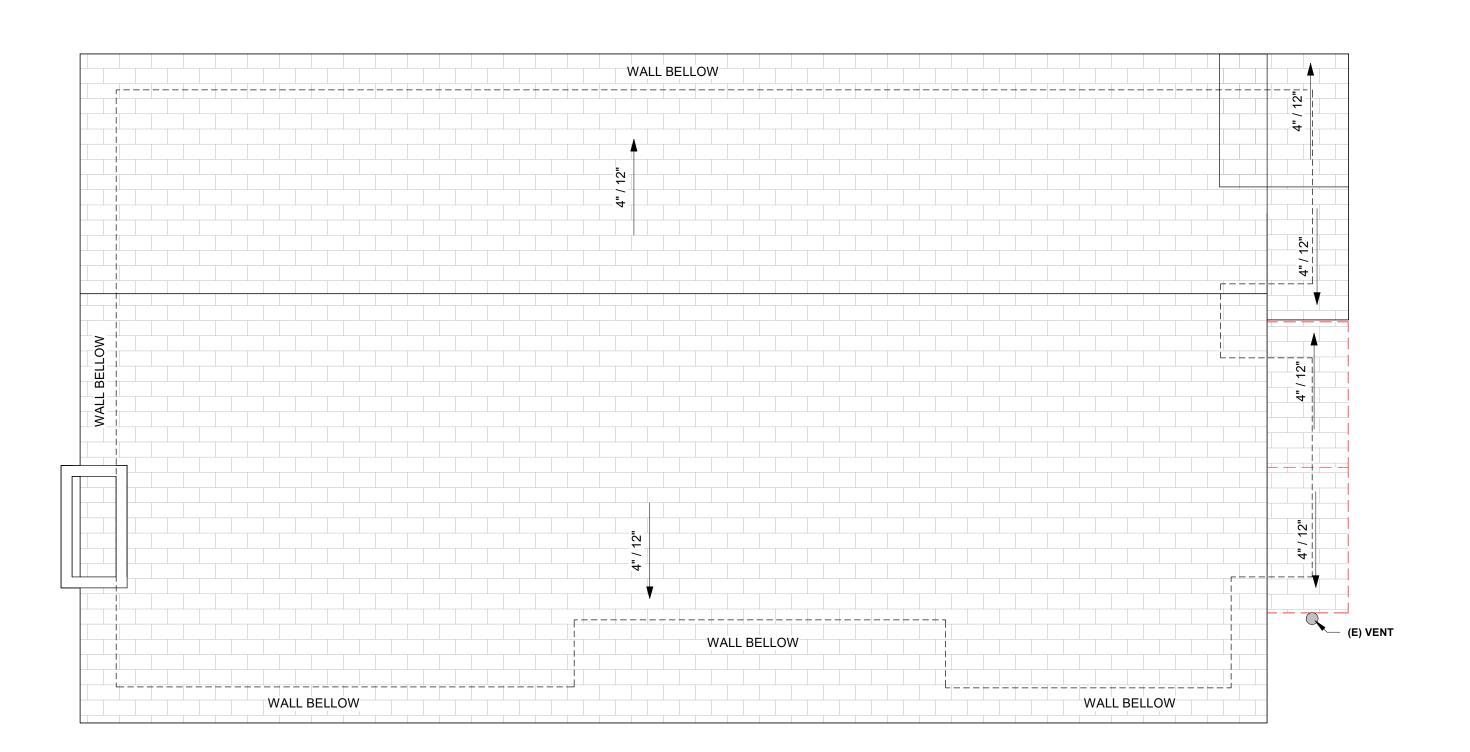



0 2'-0" 4'-0" 8'-0"

(P) ROOF PLAN 1/4" = 1'-0" 2

### **ROOF PLAN GENERAL NOTES**

ROOF MATERIAL COVERING CLASS "A" ASPHALT SHINGLES BY CERTAINTEED ICC-ESR# 3537.
COLOR & PER THE INSTALLATION OF ROOF COVERING SHALL BE IN ACCORDANCE WITH
MANUFACTURER'S SPECIFICATIONS.

2. CHIMNEY TO BE 2FT ABOVE ROOF WITHIN 10'-0" WITH SPARK ARRESTOR AND SHROUD 12" MAX. HEIGHT, TYP.

3. PROJECTIONS LESS THAN 3'-0" (HOUSE WITH SPRINKLER) OR 5'-0" (HOUSE WITH NO SPRINKLER) TO PROPERTY LINE TO BE 1-HOUR CONSTRUCTION, TYP.

4. ROOF VENT : SEE ROOF VENTILATION CALCULATION.

5. PROVIDE MIN. 2% SLOPE AT FLAT ROOF AND DECK.



CHIEF ENGINEER:LEI ZHENG (MASON)
PHONE: (510)909-1933
EMAIL: ENGINEER.LEI@GMAIL.COM

DURING CONSTRUCTION IF ANY DIFFICULTY

DURING CONSTRUCTION IF ANY DIFFICULTY OCCUR, PLEASE CONTACT ENGINEER IMMEDIATELY .IF CONTRACTOR DEVIATE FROM THE DRAWING WITHOUT PRIOR APPROVAL FROM ENGINEER, THE CONTRACTOR WILL TAKE ALL THE LIABILITY DUE TO DEVIATION.

## 755 PIERCE ST, ALBANY, CA 94706

	REV.	DESCRIPTION	DATE
	0	APPLY FOR PERMITS	04/20/24
	1	1ST PLAN CHECK	05/21/24

Jurisdiction:



SHEET TITLE:

(E)&(P)ROOF PLANS

SHEET NUMBER:



### **ELEVATION & SECTION NOTES**

1. IN COMBUSTIBLE CONSTRUCTION, FIREBLOCKING SHALL BE PROVIDED TO CUT OFF BOTH VERTICAL AND HORIZONTAL CONCEALED DRAFT OPENINGS AND TO FORM AN EFFECTIVE FIRE BARRIER BETWEEN STORIES, AND BETWEEN A TOP STORY AND THE ROOF SPACE, CRC R302.11.

2. THE REQUIRED QUALITY MARK ON EACH PIECE OF PRESSURE-PRESERVATIVE-TREATED LUMBER OR PLYWOOD SHALL CONTAIN THE FOLLOWING INFORMATION: A.IDENTIFICATION OF THE TREATING PLANT.

C.THE MINIMUM PRESERVATIVE RETENTION. D.END USE FOR WHICH THE PRODUCT WAS TREATED. E.STANDARD TO WHICH THE PRODUCT WAS TREATED. F.IDENTITY OF THE APPROVED INSPECTION AGENCY. G.THE DESIGNATION "DRY," IF APPLICABLE.

EXCEPTION: QUALITY MARKS ON LUMBER LESS THAN 1 INCH (25 MM) NOMINAL THICKNESS, OR LUMBER LESS THAN NOMINAL 1 INCH BY 5 INCHES (25 MM BY 127 MM) OR 2 INCHES BY 4 INCHES (51 MM BY 102 MM) OR LUMBER 36 INCHES (914 MM) OR LESS IN LENGTH SHALL BE APPLIED BY STAMPING THE FACES OF EXTERIOR PIECES OR BY END LABELING NOT LESS THAN 25 PERCENT OF THE PIECES OF A BUNDLED

3. ALL WALLS TO BE SMOOTH FINISH U.N.O.

4. CONTRACTOR TO INCLUDE ALL FINISH AND COLOR SPECIFIED BY OWNER AND INTERIOR DESIGNER.

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6. MIN. 3/8" CDX PLYWOOD THROUGH-OUT @ OUTSIDE FACE OF WALL

8. CONTRACTOR TO VERIFY ALL OWNER'S APPLIANCE MANUAL SPEC. PRIOR TO CONSTRUCTION.

### 9. DESIGN BUILT CABINET TO FIT

10. ALL INTERIOR, DOOR, WINDOW SIDE, HEAD AND SILL TO BE MOLDING

11. EXTERIOR CONCRETE LANDING TO COMPLY 2019 CRC R311.3 A. THERE SHALL BE A LANDING OR FLOOR ON EACH SIDE OF EACH EXTERIOR DOOR. THE WIDTH OF EACH LANDING SHALL BE NOT LESS THAN THE DOOR SERVED. EVERY LANDING SHALL HAVE A DIMENSION OF NOT LESS THAN 36 INCHES MEASURED IN THE DIRECTION OF TRAVEL. THE SLOPE AT EXTERIOR LANDINGS SHALL NOT EXCEED 1/4 UNIT VERTICAL IN 12 UNITS HORIZONTAL (2 PERCENT).

B. LANDINGS AT THE REQUIRED DOOR SHALL NOT MORE THAN 1 1/2 INCHES LOWER THAN THE TOP OF THE THRESHOLD. EXCEPTION: THE LANDING SHALL BE NOT MORE THAN 7 3/4 INCHES BELOW THE TOP OF THE THRESHOLD PROVIDED THE DOOR DOES NOT SWING OVER THE LANDING

12. SURFACE DRAINAGE SHALL BE DIVERTED TO A STORM SEWER CONVEYANCE OR OTHER APPROVED POINT OF COLLECTION THAT DOES NOT CREATE A HAZARD. LOTS SHALL BE GRADED TO DRAIN SURFACE WATER AWAY FROM FOUNDATION WALLS. THE GRADE SHALL FALL NOT FEWER THAN 6 INCHES (152 MM) WITHIN THE FIRST 10 FEET (3048 MM).

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### **LEGEND**

DOOR TYPE

WINDOW TYPE

WALL TYPE **KEY NOTE** 

FLOOR DEPRESSION



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DESCRIPTION	DATE
OR PERMITS 0	)4/20/24
CHECK 0	)5/21/24


Jurisdiction:



SHEET TITLE:

(E) ELEVATIONS

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### **ELEVATION & SECTION NOTES**
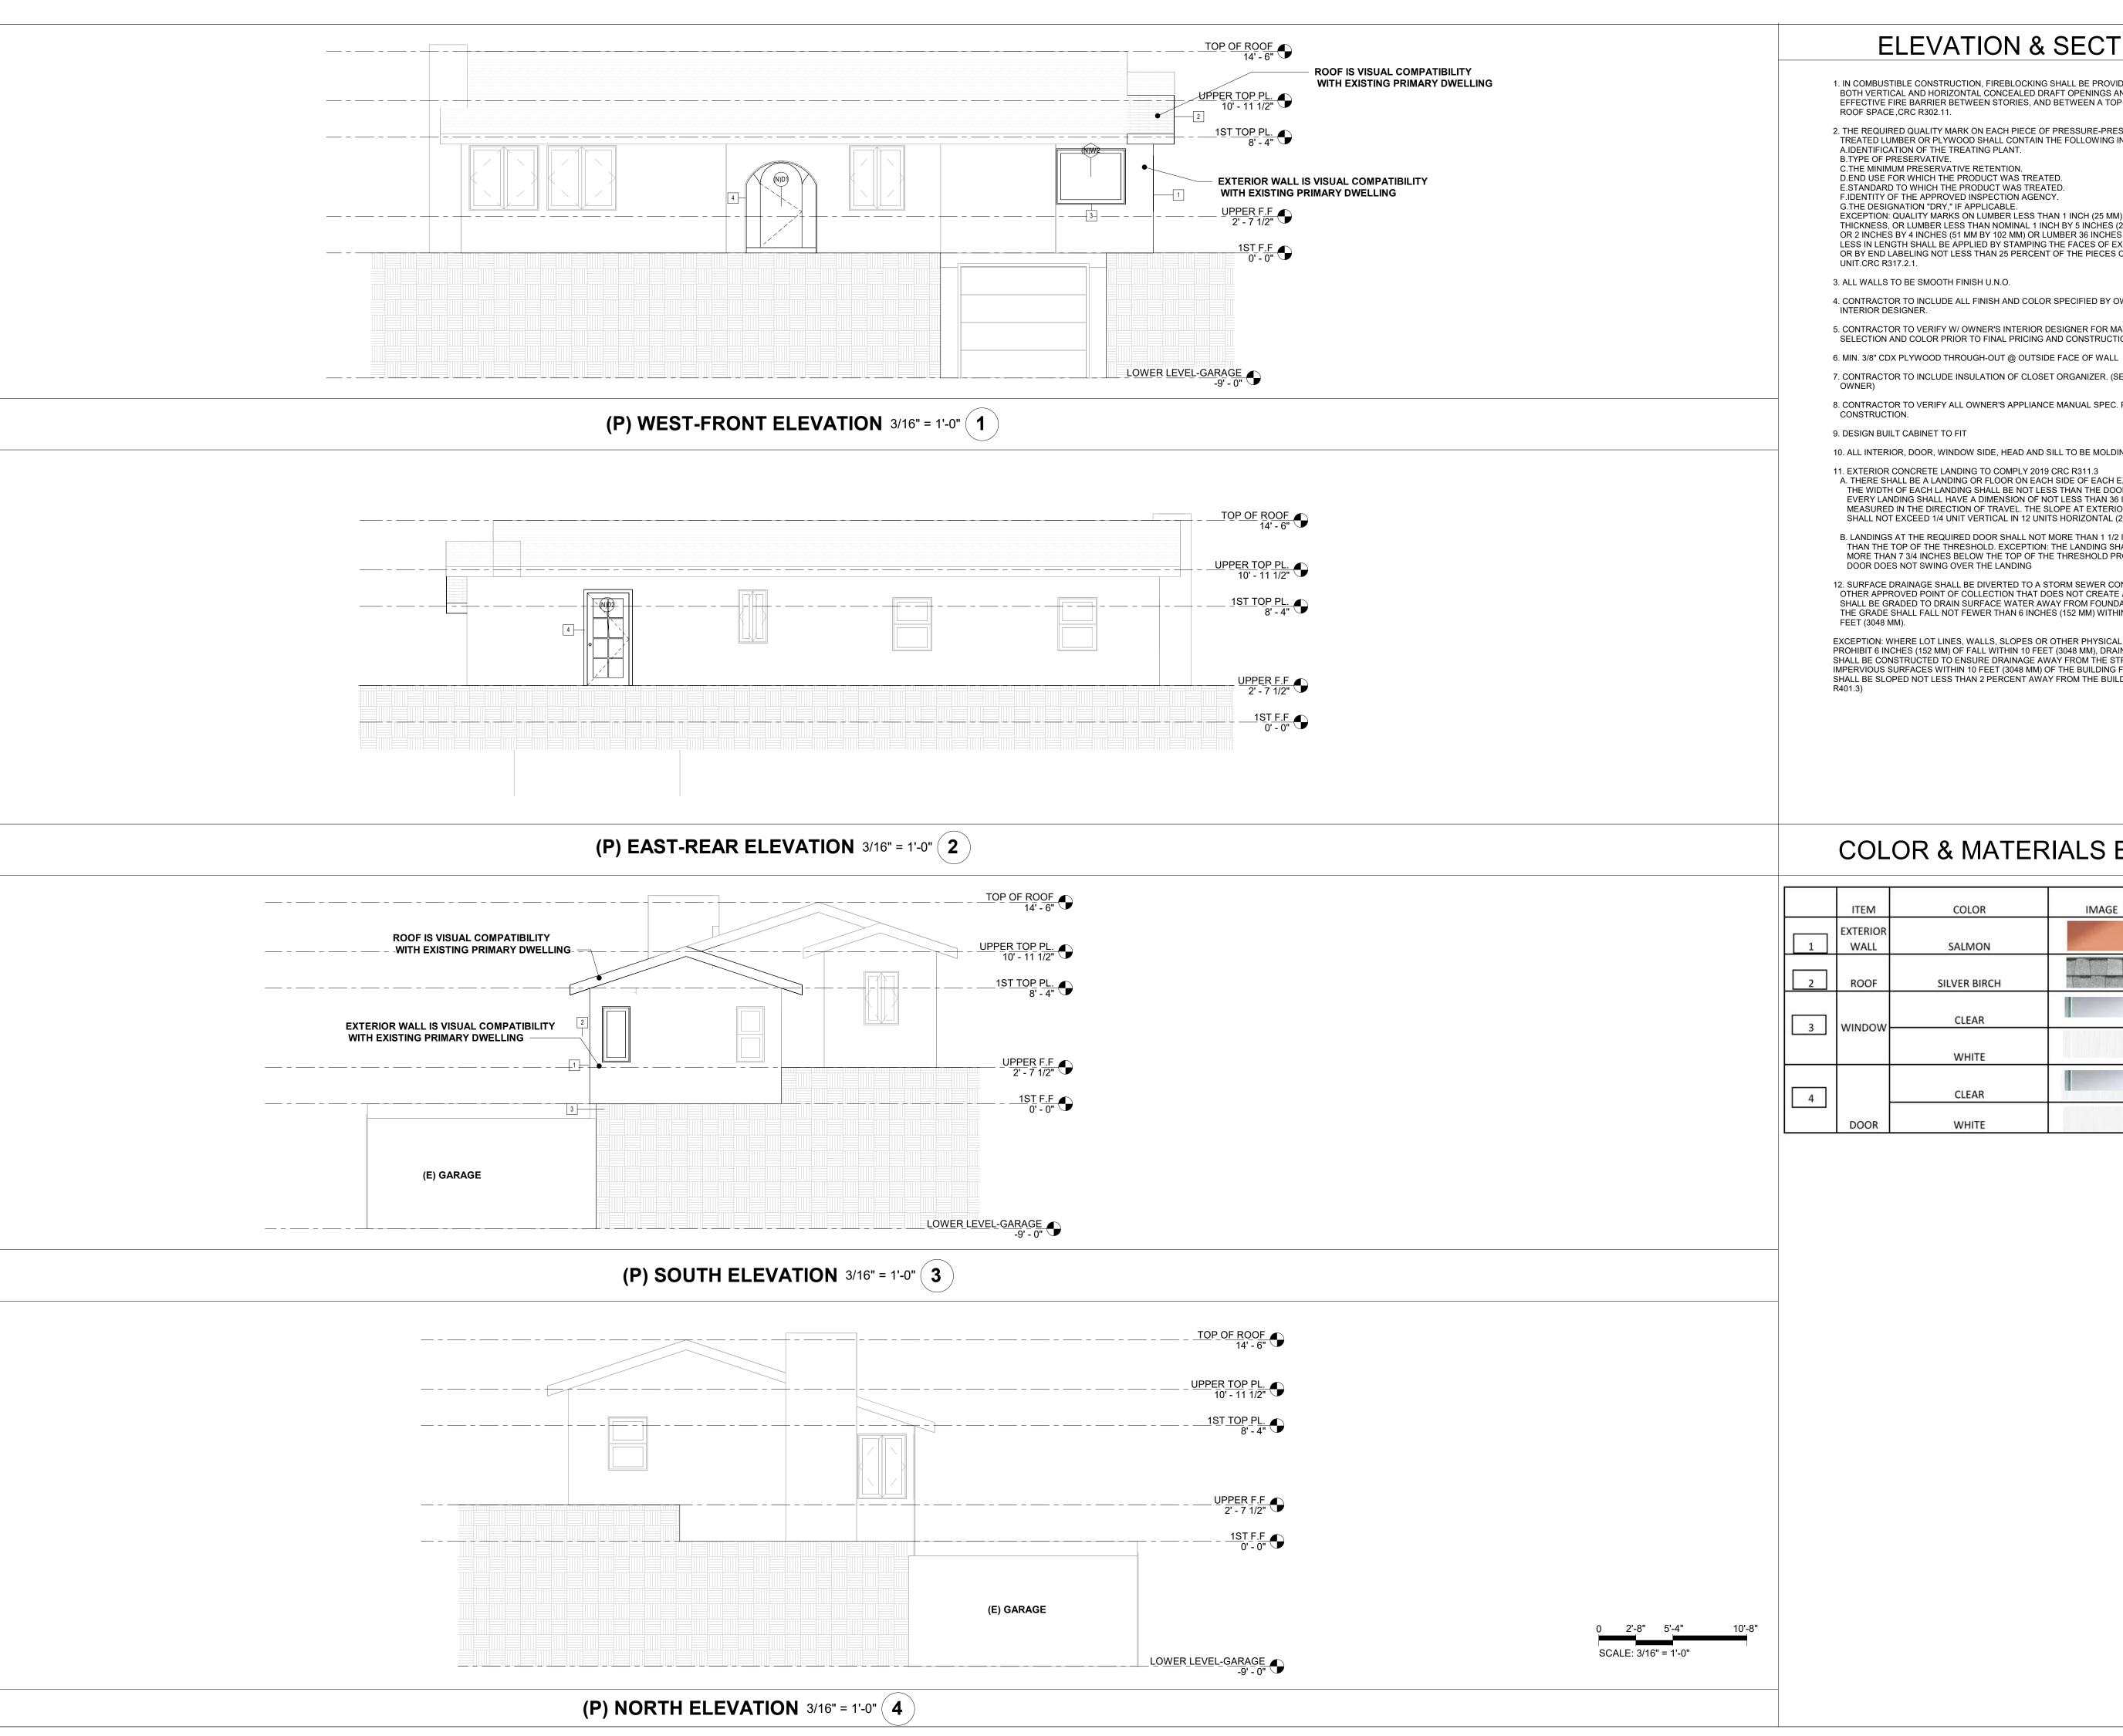
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### COLOR & MATERIALS BOARD

	ITEM	COLOR	IMAGE	MATERIAL
1	EXTERIOR WALL	SALMON		STUCCO & PAINT
2	ROOF	SILVER BIRCH		SHINGLE
3	WINDOW	CLEAR		GLASS
	VIIIDON	WHITE		FIBERGLASS
4		CLEAR		GLASS
	DOOR	WHITE		FIBERGLASS



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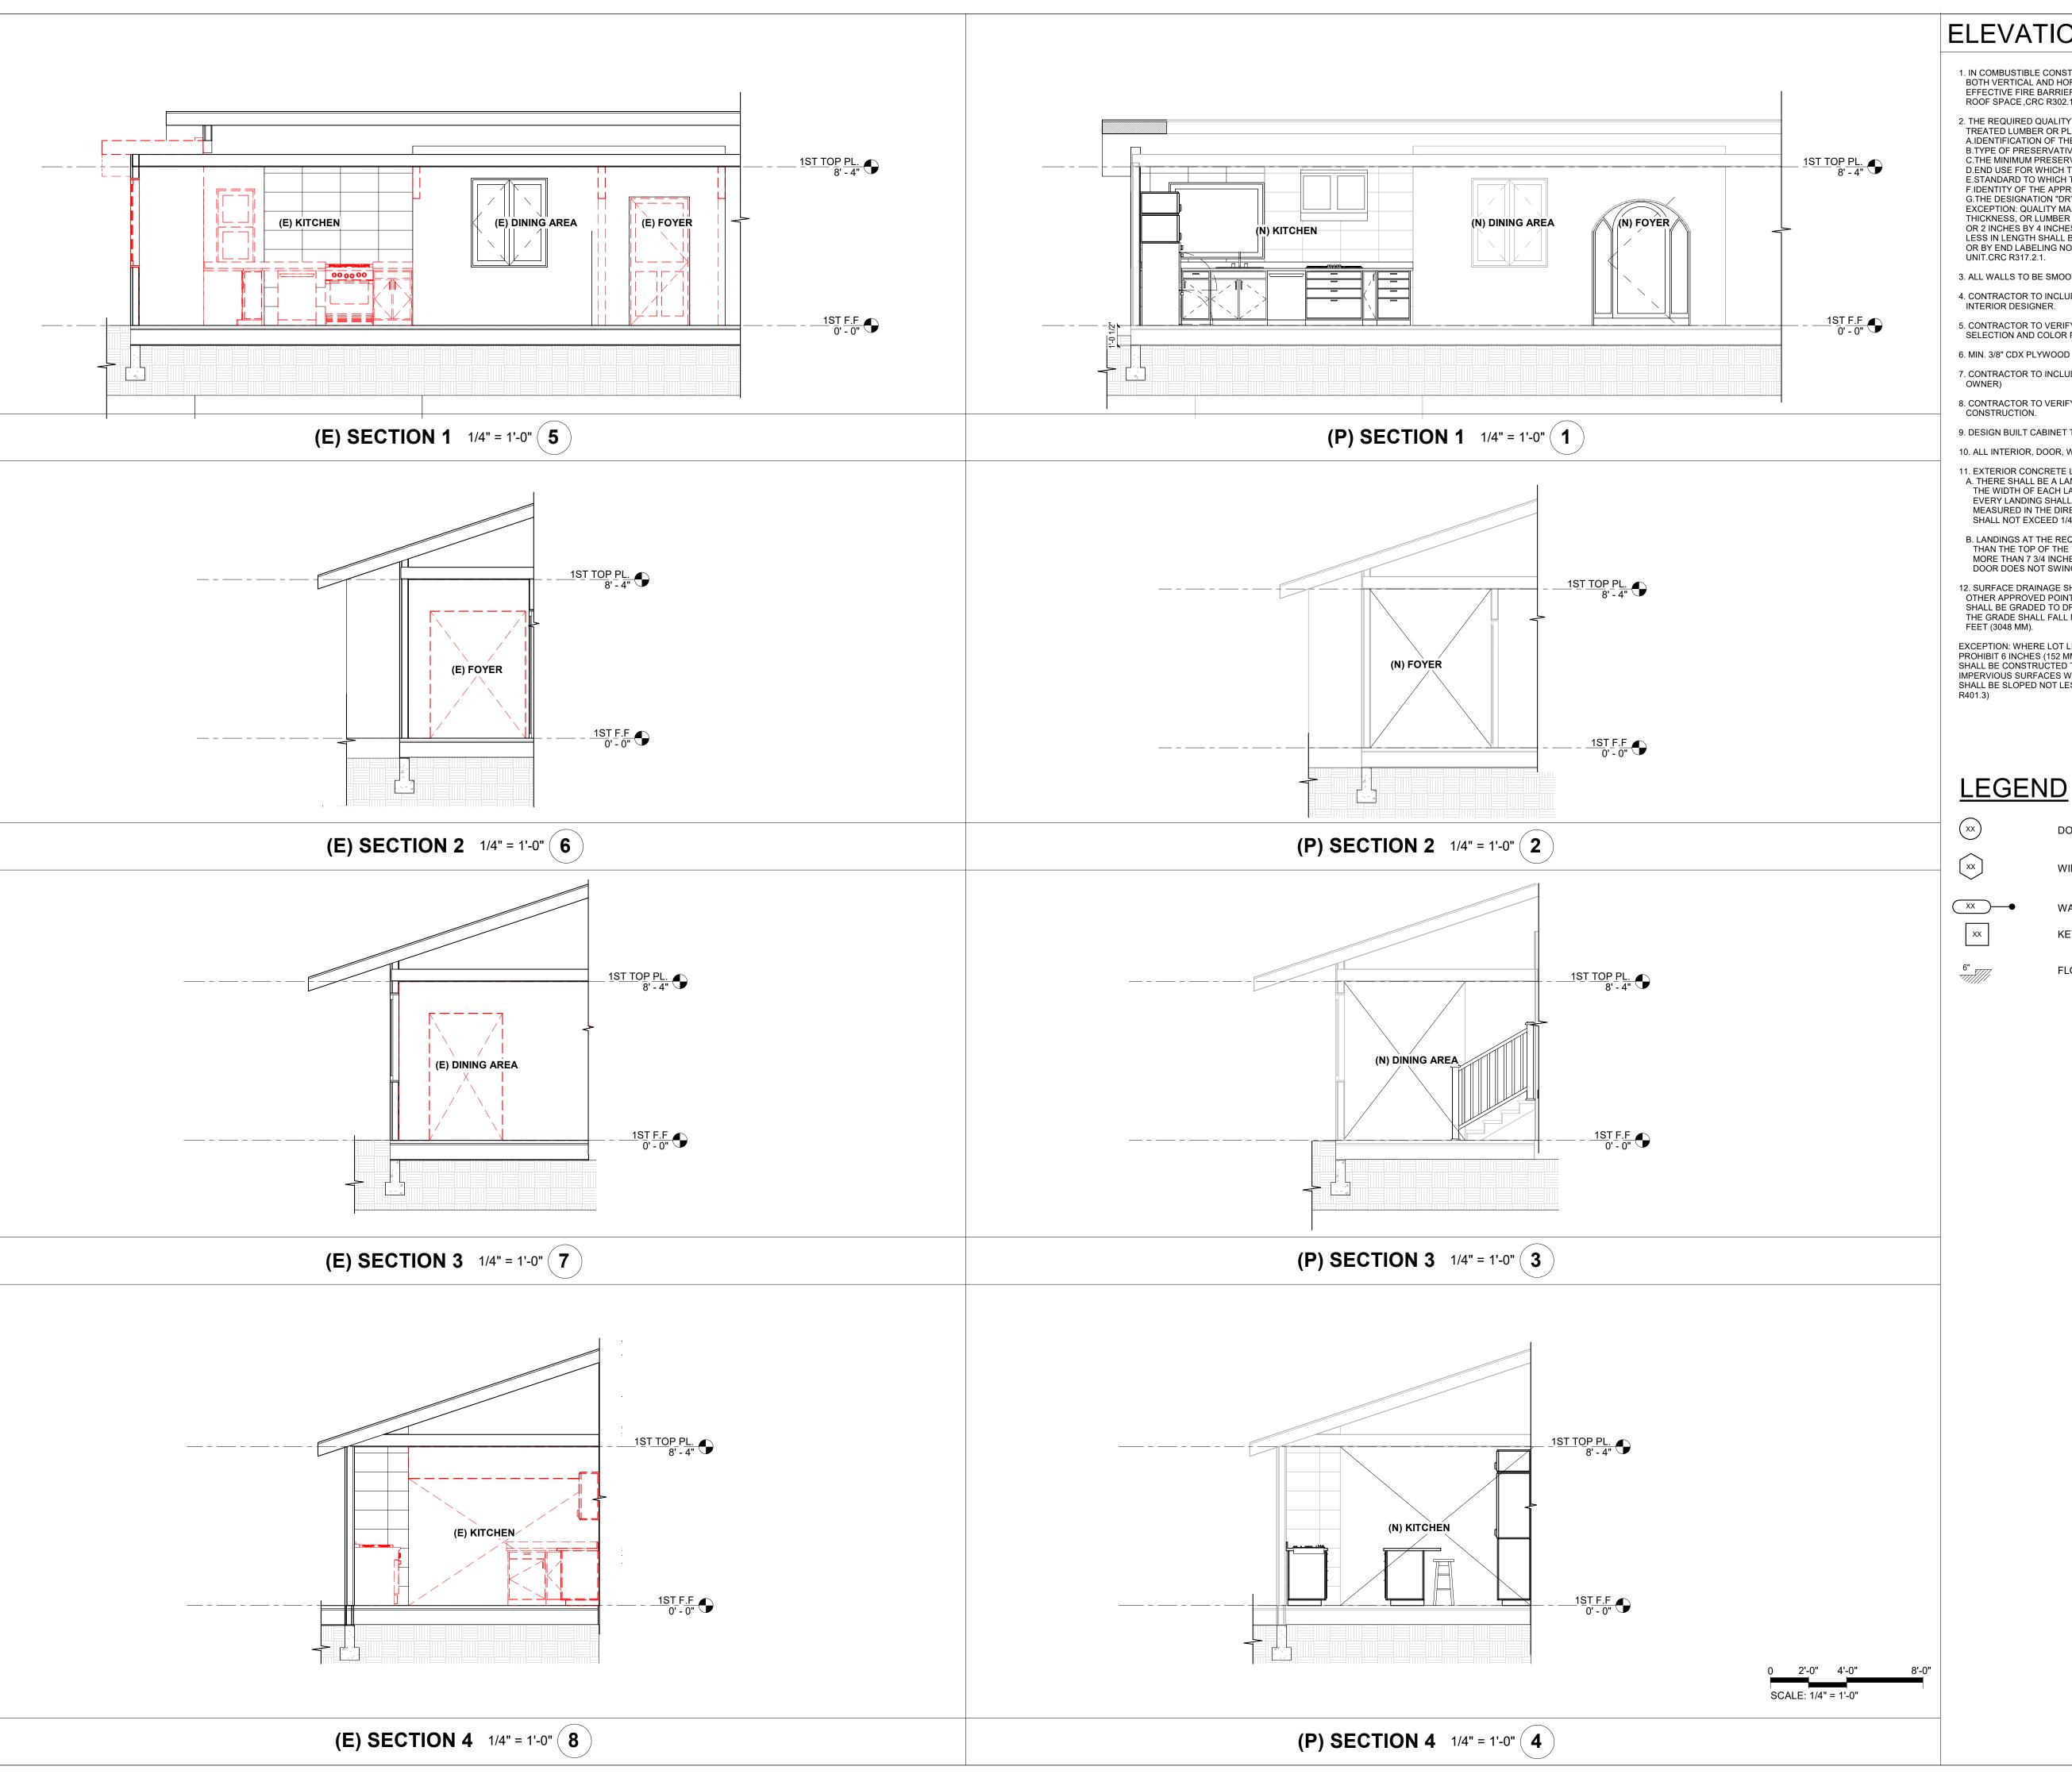
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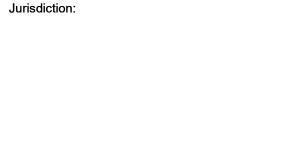
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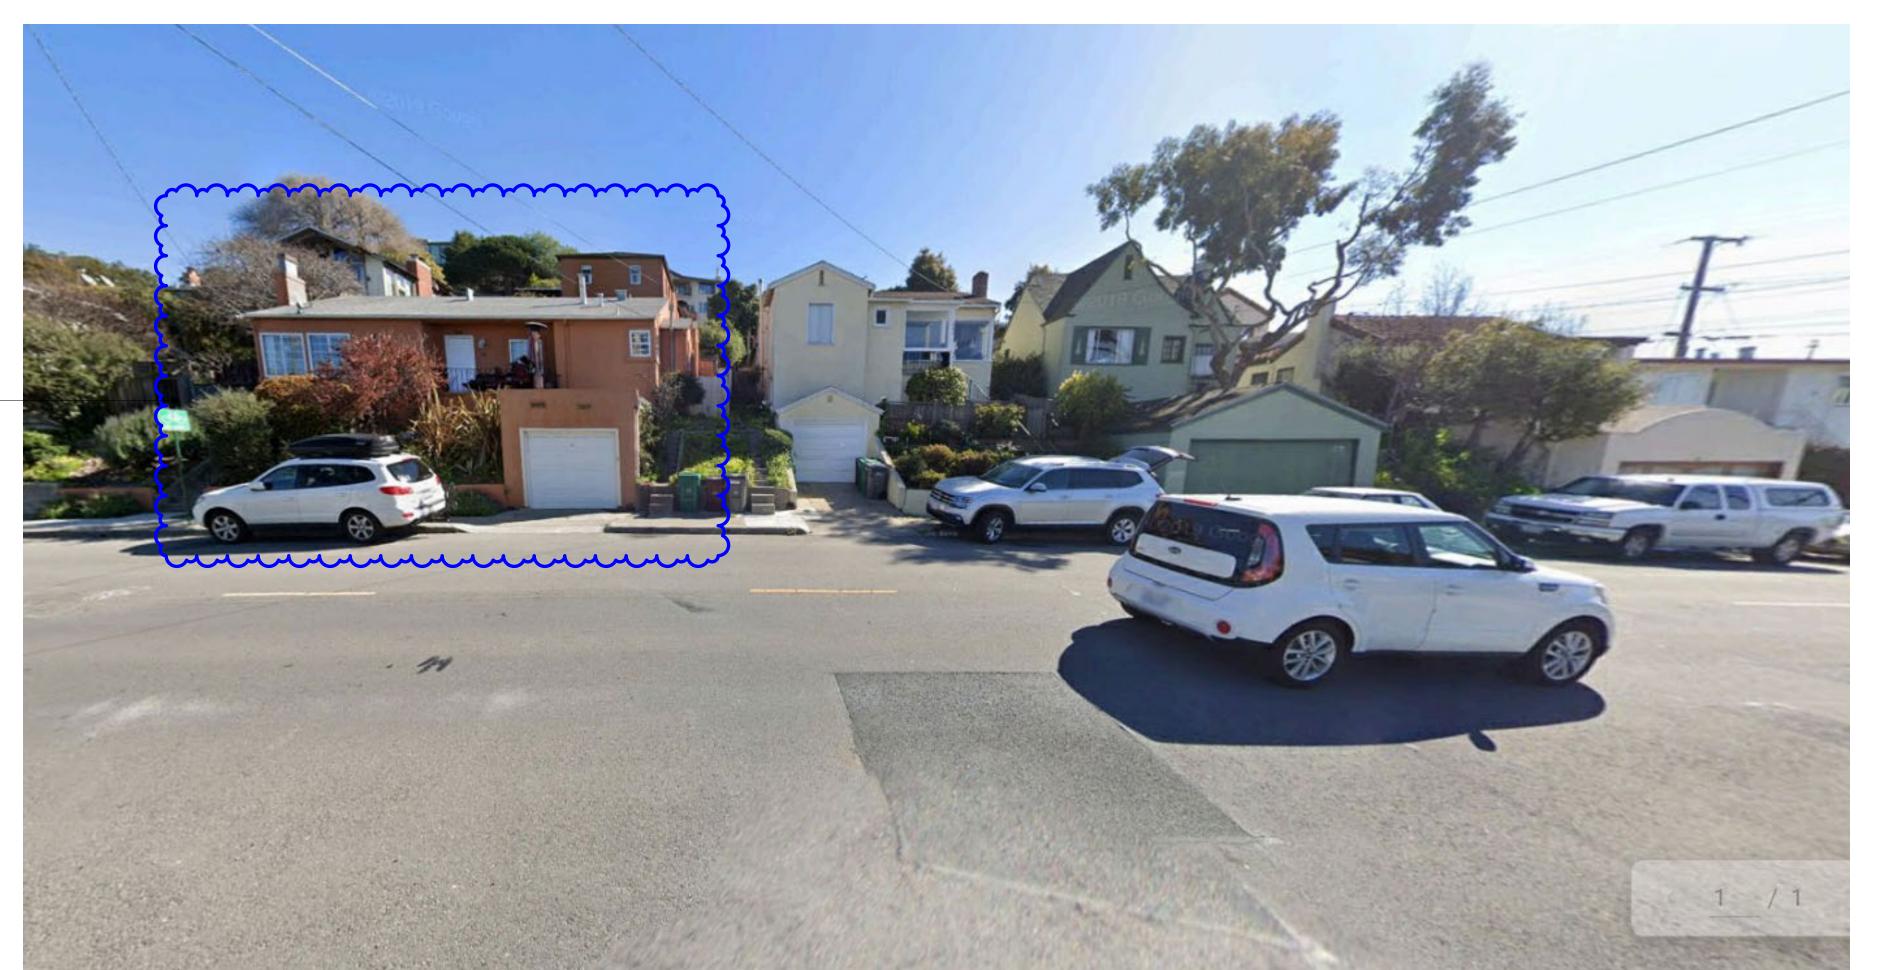
SHEET TITLE:

(E) & (P) SECTIONS

SHEET NUMBER:



— SCOPE OF WORK








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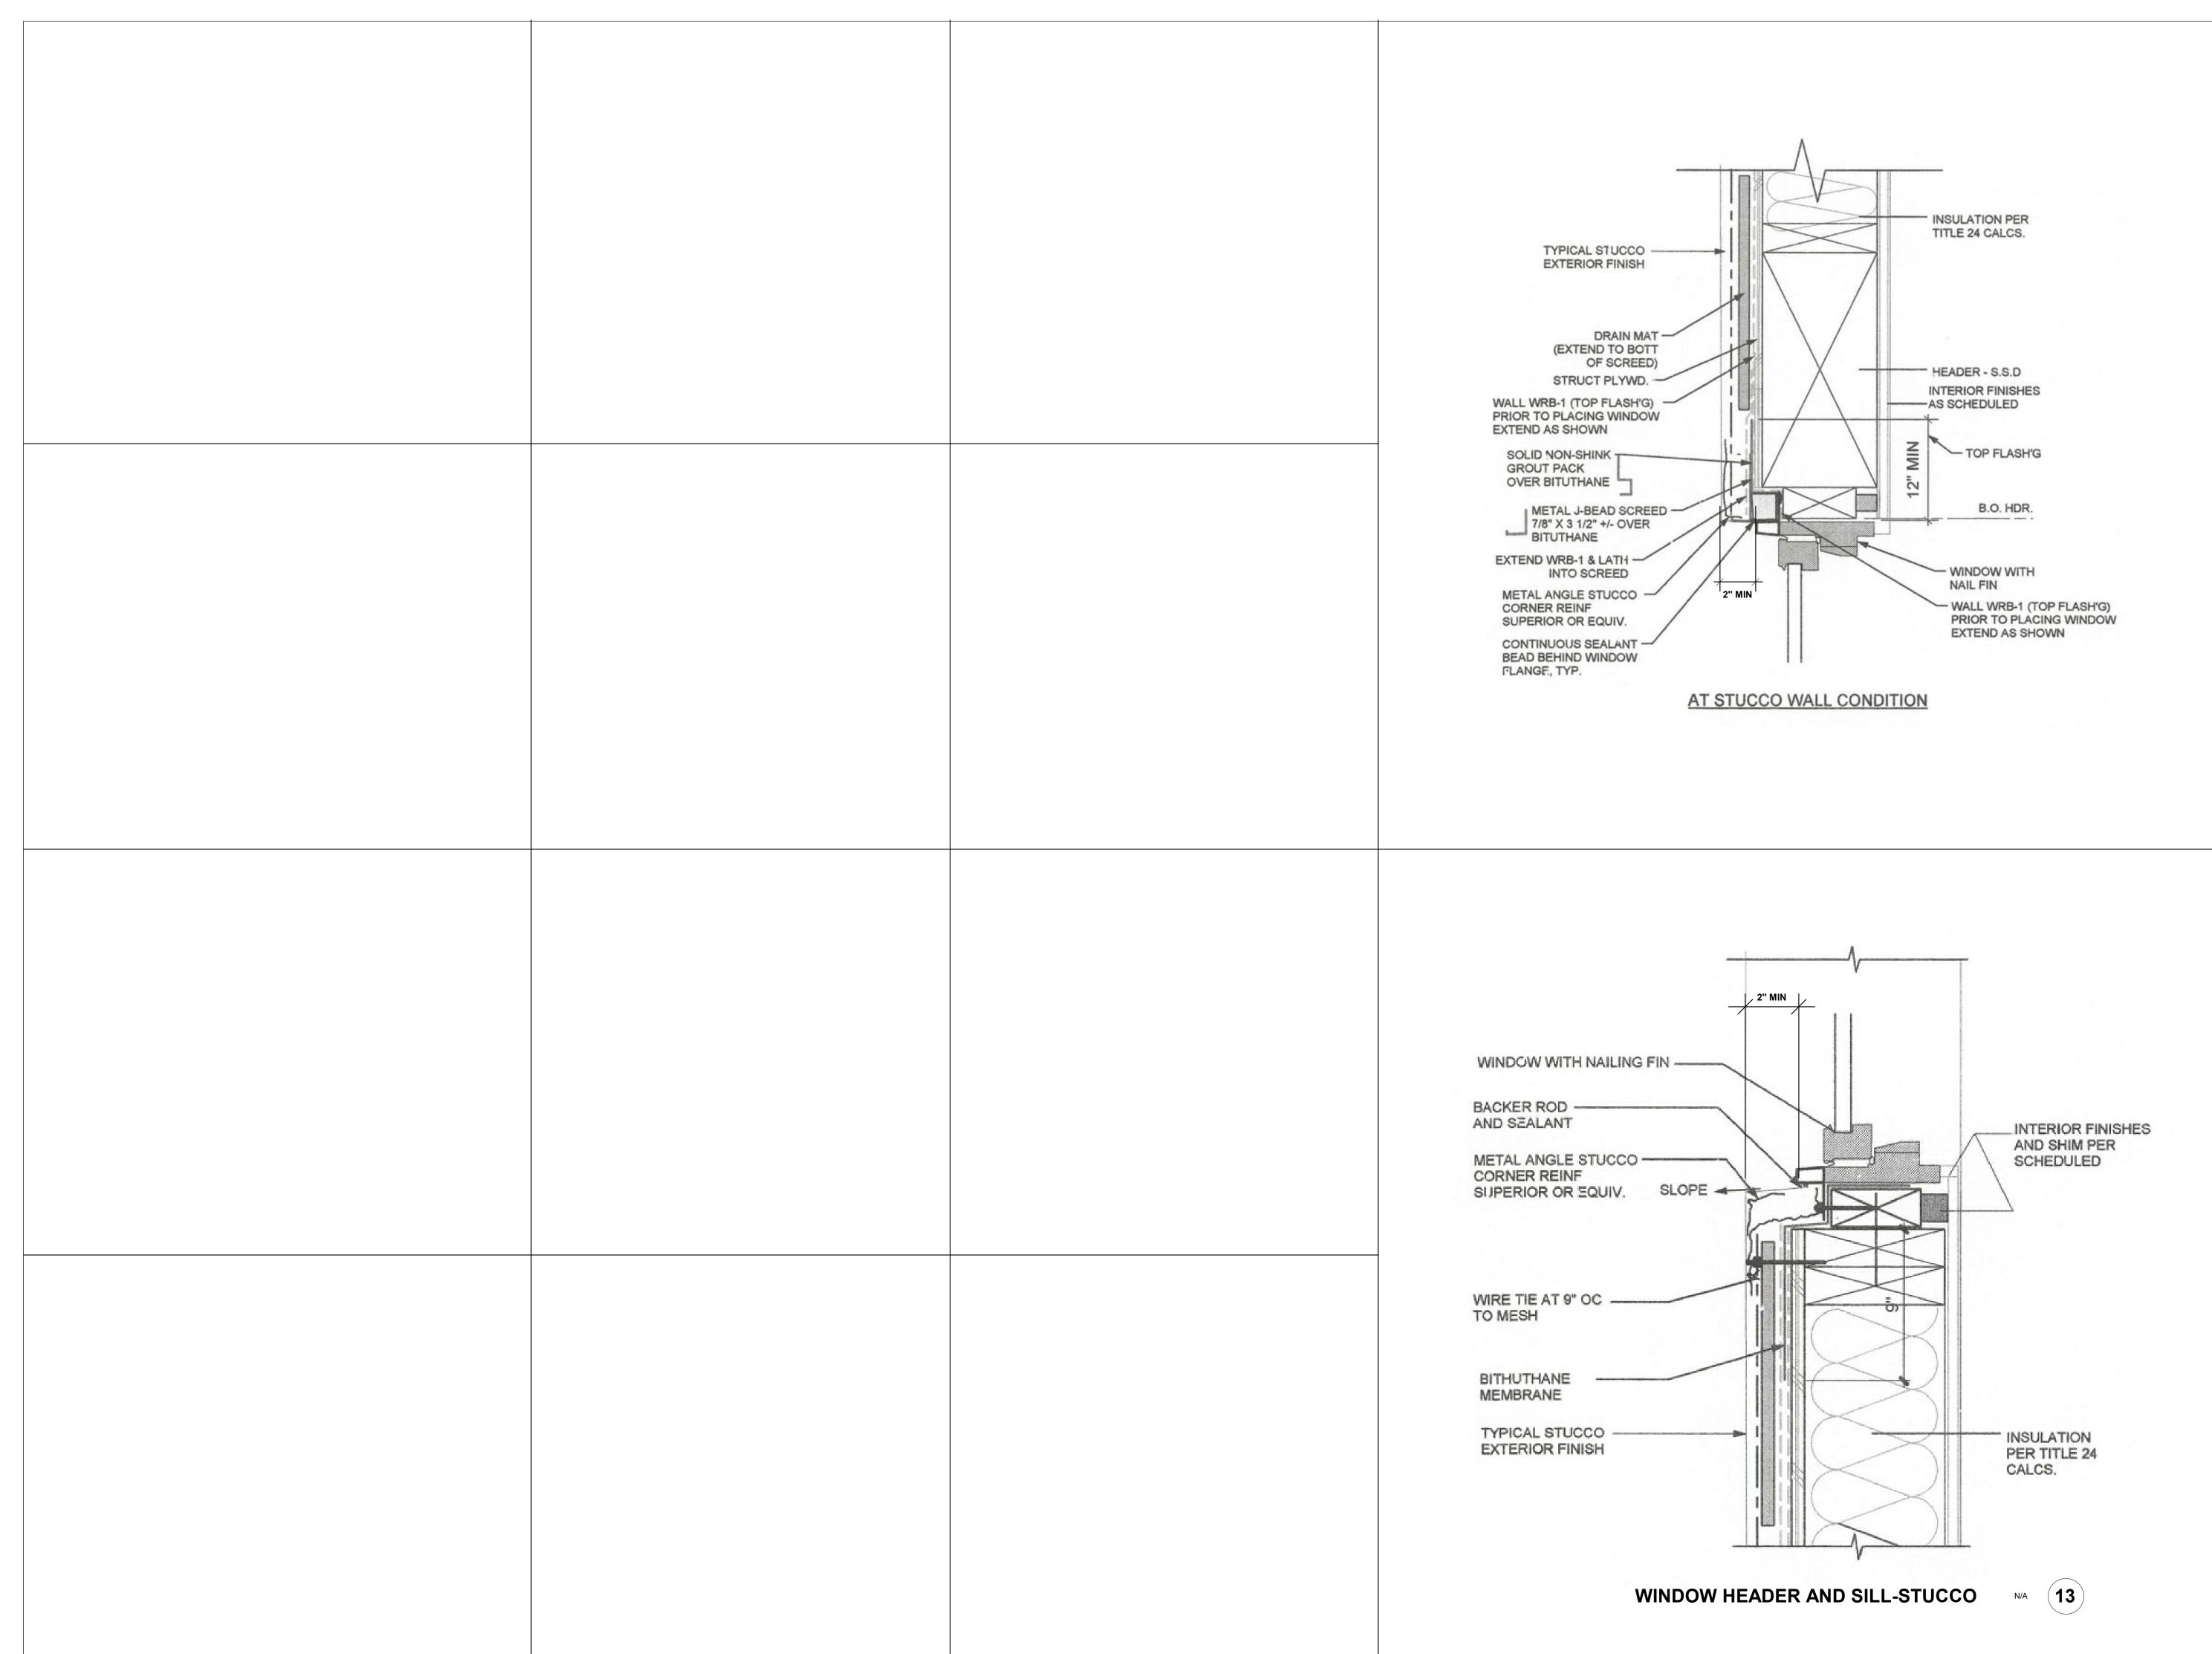
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STREET ELEVATIONS

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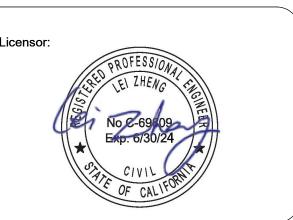
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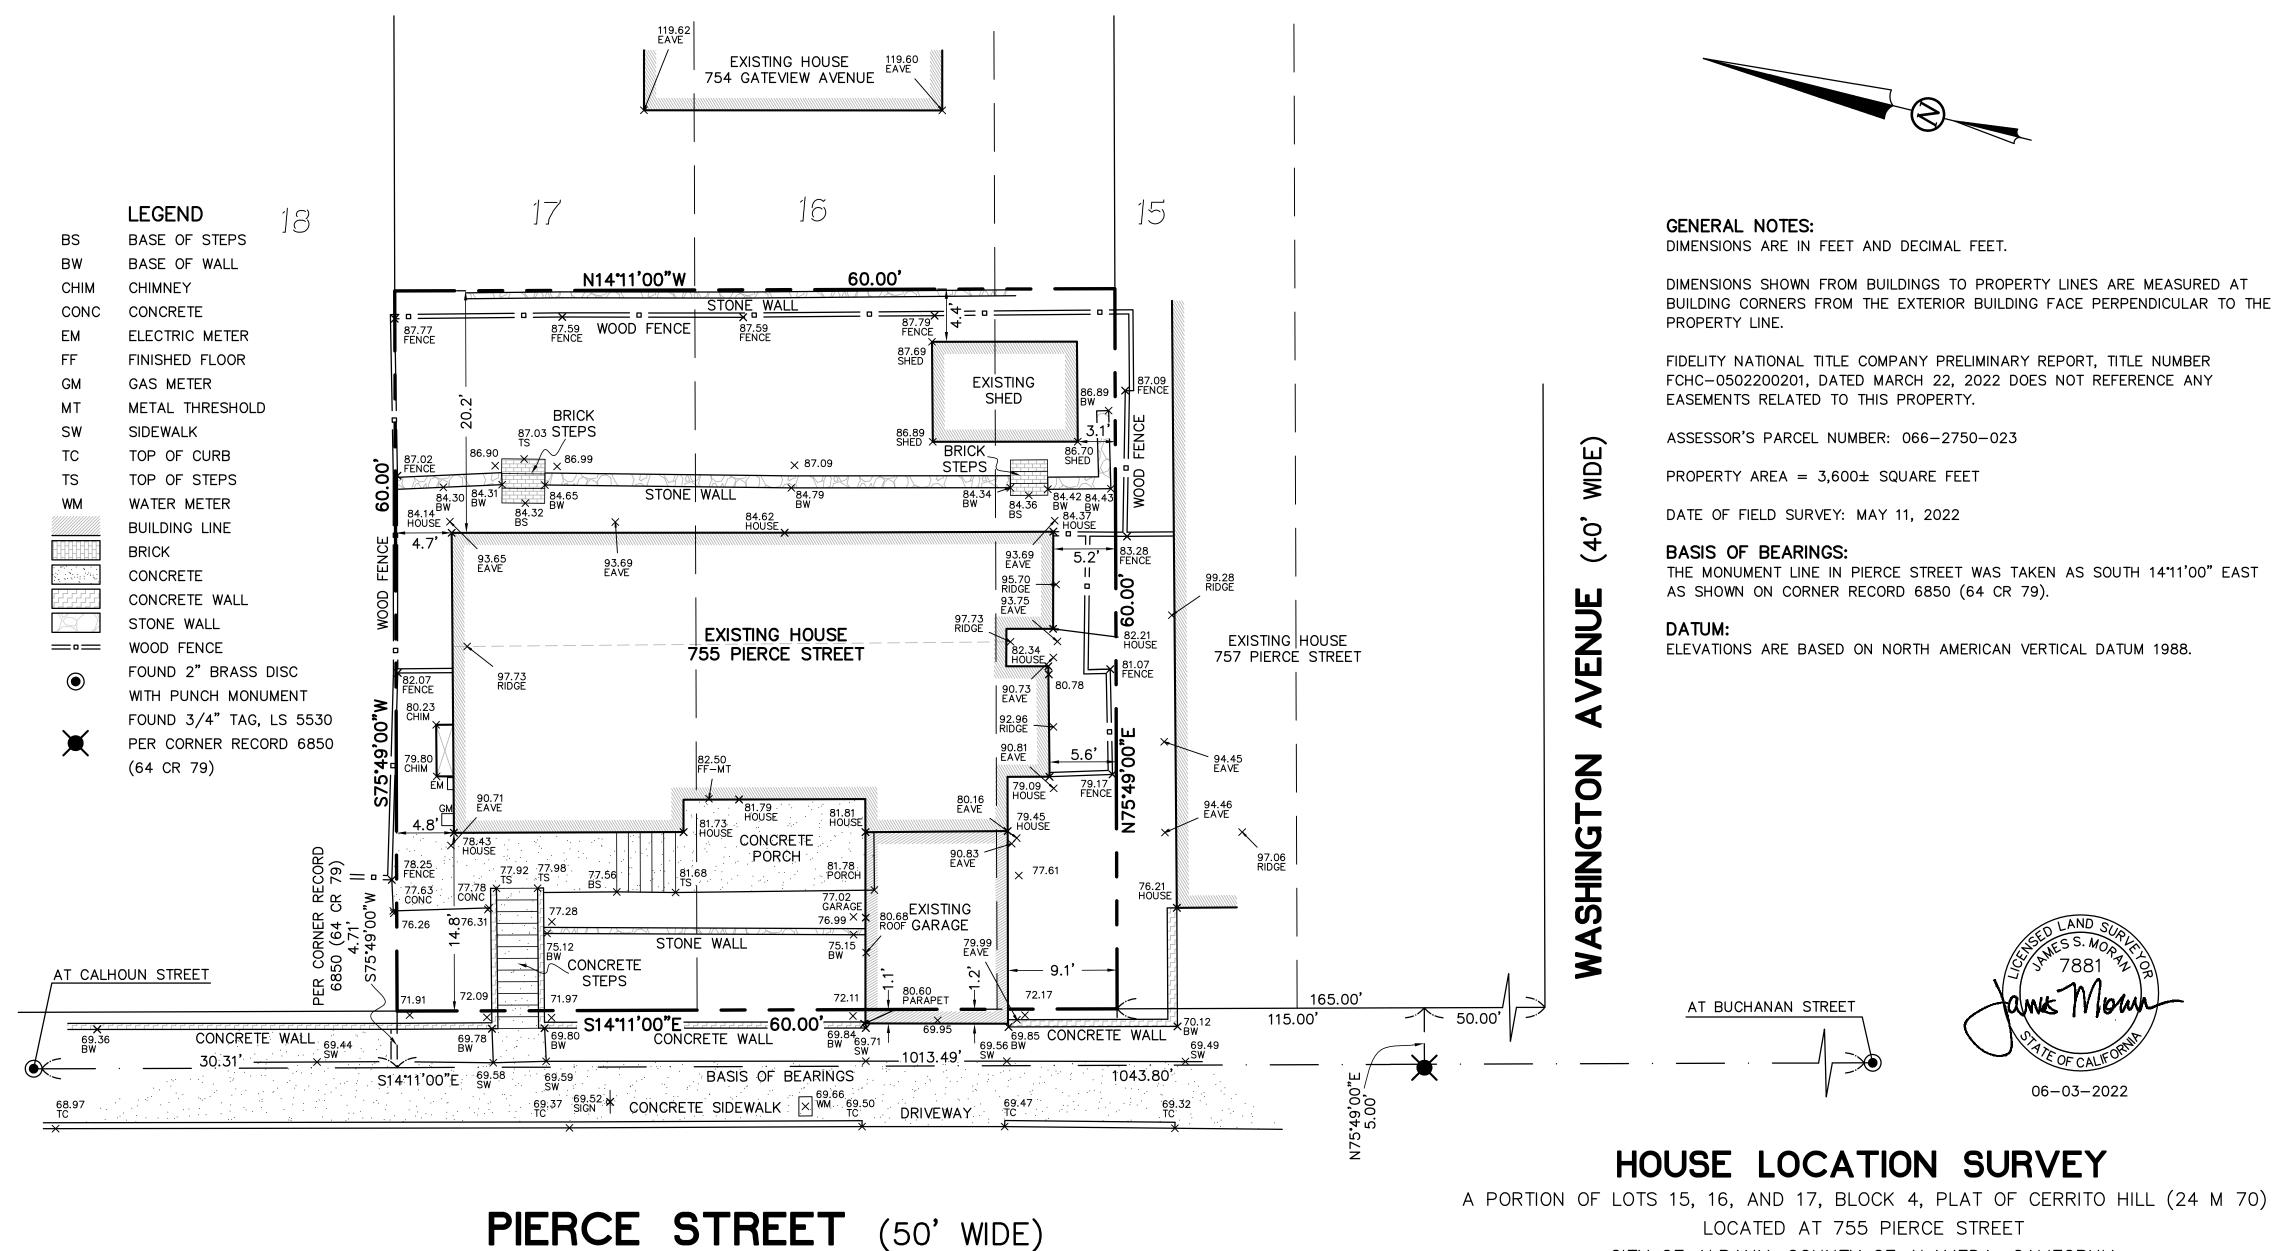



SHEET TITLE:

ARCHITECTURAL DETAILS

SHEET NUMBER:

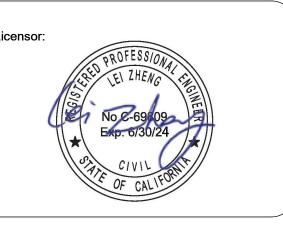AD.10



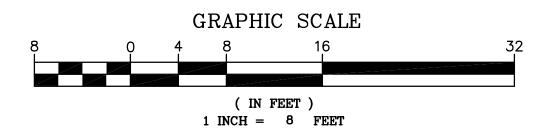

CITY OF ALBANY, COUNTY OF ALAMEDA, CALIFORNIA

JUNE 3, 2022

SCALE: 1" = 8'

### MORAN ENGINEERING, INC.

CIVIL ENGINEERS \ LAND SURVEYORS 1930 SHATTUCK AVENUE, SUITE A BERKELEY, CALIFORNIA 94704 (510) 848-1930

F.B. NO. 1890

PIERCE-HL.DWG

JOB NO. 22-10933