THE CONTRACTOR SHALL PERFORM THE WORK IN ACCORDANCE WITH ALL APPLICABLE CODES, LAWS, ORDINANACES, RULES, & REGULATIONS OF ALL GOVERNING AGENCIES. (SEE CODE REFERENCES, THIS SHEET)

THE CONTRACTOR & SUBCONTRACTORS SHALL PURCHASE & MAINTAIN CERTIFICATIONS OF INSURANCE WITH RESPECT TO WORKERS COMPENSATION, PUBLIC LIABILITY & PROPERTY DAMAGE FOR THE LIMITS AS REQUIRED BY LAW. THE CERTIFICATES SHALL NAME THE OWNER AS ADDITIONALLY INSURED.

THE CONTRACTOR SHALL BE RESPONSIBLE FOR INITIATING, MAINTAINING, & SUPERVISING ALL SAFETY PRECAUTIONS IN

CONNECTION WITH THE WORK INCLUDING BUT NOT LIMITED TO THE PROTECTION OF PEDESTRIANS & ADJACENT PROPERTIES THE CONTRACTOR SHALL CONFINE OPERATIONS AT THE SITE TO AREAS PERMITTED BY LAW, ORDINANCES, PERMITS & THE CONTRACT DOCUMENTS

THROUGHOUT THE DURATION OF THE PROJECT THE CONTRACTOR SHALL REFRAIN FROM ACTIONS THAT COULD LEAD TO THE FILING OF A CLAIM OF LIEN AGAINST THE OWNER BY SUBCONTRACTORS OR SUPPLIERS OF MATERIALS, LABOR, SERVICE, OR EQUIPMENT OR ANY OTHER INDIVIDUAL OR COMPANY SO ENTITLED UNDER GOVERNING LAWS & REGULATIONS UNLESS HE CAN SHOW REASONABLE & JUSTIFIABLE CAUSE. APPROVAL FOR FINAL PAYMENT SHALL BE CONTINGENT UPON THE CONTRACTOR'S OBTAINING & FURNISHING TO THE DESIGNER UPON REQUEST THE SIGNED RELEASES FROM SUCH INDIVIDUALS OR COMPANIES.

DRAWINGS & SPECIFICATIONS ARE INTENDED FOR ASSISTANCE & GUIDANCE BUT EXACT DIMENSIONS & ELEVATIONS SHALL BE

GOVERNED BY ACTUAL FIELD CONDITIONS & SHALL BE CHECKED BY THE CONTRACTOR. THE CONTRACTOR SHALL BE RESPONSIBLE FOR CHECKING CONTRACT DOCUMENTS, FIELD CONDITIONS, & DIMENSIONS FOR

ACCURACY & FOR CONFIRMING THAT THE PROJECT IS BUILDABLE AS SHOWN BEFORE PROCEEDING WITH THE CONSTRUCTION. IF THERE ARE ANY QUESTIONS REGARDING THESE OR OTHER COORDINATION QUESTIONS, THE CONTRACTOR SHALL SUBMIT THEM IN WRITING & IS RESPONSIBLE FOR OBTAINING A WRITTEN CLARIFICATION FROM THE DESIGNER BEFORE PROCEEDING WITH THE WORK COMMENCEMENT OF WORK BY ANY TRADE SHALL CONSTITUTE AGREEMENT THAT CONDITIONS ARE ACCEPTABLE FOR SUCH WORK.

SHOP & FIELD WORK SHALL BE PERFORMED BY MECHANICS, CRAFTSMEN, & WORKERS SKILLED & EXPERIENCED IN THE FABRICATION & INSTALLATION OF THE WORK INVOLVED. WORK SHALL BE PERFORMED IN ACCORDANCE WITH THE BEST ESTABLISHED PRACTICE OF THE INDUSTRY STANDARD FOR THE TRADES INVOLVED U.O.N. IN DRAWINGS OR SPECIFICATIONS

I. CONTRACTOR SHALL INSTALL PRODUCTS & APPLY FINISHES IN ACCORDANCE WITH MANUFACTURER'S INSTRUCTIONS &SPECIFICATIONS

12. THE CONTRACTOR SHALL PERFORM NO PORTION OF THE WORK AT ANY TIME WITHOUT CONTRACT DOCUMENTS OR, WHERE REQUIRED, APPROVED SHOP DRAWINGS, PRODUCT DATA, OR SAMPLES FOR SUCH PORTION OF THE WORK.

3. THE DRAWINGS & SPECIFICATIONS ARE COMPLIMENTARY, EVERY EFFORT HAS BEEN MADE TO COORDINATE THE DRAWINGS & SPECIFICATIONS OF THE DESIGNER & THE CONSULTING ENGINEERS. IT IS INTENDED THAT THE CONTRACTOR PROVIDE A COMPLETE JOB & ANY OMISSIONS IN THESE NOTES OR IN THE OUTLINE OF WORK SHALL NOT BE CONSTRUED AS RELIEVING THE CONTRACTOR OF SUCH RESPONSIBILITIES IMPLIED BY THE SCOPE OF WORK EXCEPT FOR ITEMS SPECIFICALLY NOTED. ANY ITEM. INSTRUCTION ETC., SHOWN IN ONE LOCATION SHALL BE REQUIRED AS IF SHOWN ON ALL APPLICABLE LOCATIONS. IN CASE OF DISCREPANCY CONSULT WITH DESIGNER BEFORE PROCEEDING.

4. WHEN PORTIONS OF THE PROJECT ARE PERFORMED BY THE CONTRACTOR ON A "DESIGN-BUILD" BASIS, THE CONTRACTOR SHALL BE SOLELY RESPONSIBLE FOR THE DESIGN OF SUCH SYSTEMS & FOR THE SECURING OF ALL ASSOCIATED PERMITS. THE GENERAL CONTRACTOR SHALL BE RESPONSIBLE FOR THE COORDINATION OF THE DESIGN BUILD SUBCONTRACTORS, WHO SHALL BE THE ENGINEERS OF RECORD FOR SUCH SYSTEMS. DESIGN BUILD DRAWINGS SHALL BE SUBMITTED TO THE DESIGNER FOR REVIEW & APPROVAL U.O.N

5. CONTRACTOR TO PROVIDE STRICT CONTROL OF JOB CLEANING & PREVENT DUST & DEBRIS FROM EMANATING FROM THE CONSTRUCTION AREA. REMOVE & LAWFULLY DISPOSE OFF SITE ALL RUBBISH & DEBRIS RESULTING FROM CONTRACTOR'S OPERATIONS DAILY. REMOVE RUBBISH & DEBRIS AS IT ACCUMULATES & KEEP AREA BROOM CLEAN. CONTRACTOR SHALL NOT STORE RUBBISH ON SITE.

6. WHEN WORK IS PERFORMED WITHIN OCCUPIED BUILDINGS, THE CONTRACTOR SHALL EMPLOY ALL AVAILABLE TECHNIQUES FOR NOISE ABATEMENT

7. WHEN THE OWNER OCCUPIES THE PREMISES DURING CONSTRUCTION, THE CONTRACTOR & HIS FORCES SHALL ENDEAVOR TO DISTURB THE OWNER AS LITTLE AS POSSIBLE DURING CONSTRUCTION. AREAS WHERE CONSTRUCTION ACTIVITY IS TAKING PLACE SHALL BE SEALED OFF FROM UNDISTURBED PORTIONS. A CLEAN, SAFE ENTRY PATH SHALL BE MAINTAINED AT ALL TIMES FOR THE

8. THE CONTRACTOR SHALL PREPARE & SUBMIT A CONSTRUCTION SCHEDULE FOR THE WORK GIVING APPROXIMATE ON SITE DELIVERY DATES FOR CONSTRUCTION MATERIALS. THE SCHEDULE SHALL BE SUBMITTED AS PART OF THE BID. THIS SCHEDULE WITH NECESSARY MODIFICATIONS AS MUTUALLY AGREEABLE TO OWNER & CONTRACTOR SHALL BECOME PART OF THE CONTRACT FOR CONSTRUCTION. SUBSTITUTIONS BASED UPON DELIVERY DATES OF SPECIFIED PRODUCTS WILL NOT BE ACCEPTED AFTER CONSTRUCTION HAS COMMENCED.

19. THE WORK SHALL INCLUDE THE PROVISION OF ALL LABOR, MATERIALS, DELIVERY & EQUIPMENT, INCLUDING SCAFFOLDING, SHORING, DISPOSAL, ETC. AS REQUIRED FOR A COMPLETE INSTALLATION OF THE WORK AS INDICATED HEREIN ON THE CONSTRUCTION DOCUMENTS. ALL WORK LISTED. SHOWN OR IMPLIED ON ANY CONSTRUCTION DOCUMENT SHALL BE SUPPLIED & INSTALLED BY THE GENERAL CONTRACTOR EXCEPT WHERE NOTED OTHERWISE. GENERAL CONTRACTOR SHALL COORDINATE HIS WORK WITH THAT OF OTHER CONTRACTORS OR VENDORS TO ASSURE THAT ALL SCHEDULES ARE MET & THAT ALL WORK IS DONE IN CONFORMANCE WITH THE CONTRACT DOCUMENTS & MANUFACTURER'S REQUIREMENTS

20. THE CONTRACTOR SHALL BE RESPONSIBLE FOR THE DISTRIBUTION OF DRAWINGS TO ALL TRADES UNDER CONTRACTOR'S

SUPERVISION & SHALL MAINTAIN CURRENT CONSTRUCTION DOCUMENTS ON THE JOB SITE DURING ALL PHASES OF CONSTRUCTION 1. THE GENERAL CONTRACTOR SHALL HAVE A SUPERINTENDENT AT THE JOB SITE WHENEVER ANY WORK IS BEING PERFORMED. IN

ORDER TO PROVIDE CONSTANT SUPERVISION. 22. The contractor shall prepare, review, approve, & submit to the designer all shop drawings. The contractor SHALL CHECK & COORDINATE ALL PRODUCT DATA & SAMPLES & VERIFY THAT ALL MATERIALS, FIELD MEASUREMENTS, & RELATED FIELD CONSTRUCTION CRITERIA CONTAINED WITHIN SUCH SUBMITTALS CONFORMS WITH THE REQUIREMENTS OF THE WORK. THE

PROJECT, & THE CONTRACT DOCUMENTS. USE THE DESIGNER'S SUBMITTAL FORM. THE DESIGNER WILL NOT REVIEW, APPROVE, OR TAKE THE APPROPRIATE ACTION ON SHOP DRAWINGS, PRODUCT DATA, & SAMPLES UNLESS THE CONTRACTOR HAS SUBMITTED A RECOMMENDATION FOR ACTION. SUBMIT SHOP DRAWINGS, MOCK-UPS, SAMPLES, & OTHER REQUIRED SUBMITTALS SUBMITTALS IN A TIMELY MANNER SO AS NOT TO DELAY THE PROJECT. ALLOW THE DESIGNER ONE WEEK FOR REVIEW & APPROVAL 3. THERE SHALL BE NO SUBSTITUTIONS OF MATERIALS WHERE A MANUFACTURER IS SPECIFIED. WHERE THE TERM "OR APPROVED EQUAL" IS USED, THE DESIGNER ALONE SHALL DETERMINE QUALITY BASED UPON COMPLETE INFORMATION SUBMITTED BY THE

CONTRACTOR. SUBSTITUTIONS SHALL NOT BE MADE UNLESS DRAWINGS &/OR CUT SHEETS ARE SUBMITTED TO THE DESIGNER FOR 24. UPON COMPLETION OF THE WORK OR SHORTLY BEFORE, THE CONTRACTOR SHALL DIRECT THE DESIGNER & ENGINEERS TO PREPARE

A "PUNCH LIST" OF CORRECTIONS & UNSATISFACTORY &/OR INCOMPLETE WORK. FINAL PAYMENT SHALL BE CONTINGENT UPON THE COMPLETION OF THESE ITEMS UNDER THE TERMS OF THE OWNER - CONTRACTOR AGREEMENT 15 . The contractor shall furnish to the owner two copies of manufacturer's instruction, operation, & maintenance

MANUALS FOR PRODUCTS & EQUIPMENT SPECIFIED IN THE CONTRACT DOCUMENTS. INCLUDING SPECIAL TOOLS. ACCESSORIES. SPARE PARTS, ETC. 6. GENERAL CONTRACTOR SHALL PROVIDE WRITTEN ONE (1) YEAR WARRANTY FOR ALL WORK PERFORMED, EXCEPT WHERE NOTED

OTHERWISE. WARRANTY PERIOD SHALL COMMENCE AT THE DATE OF OCCUPANCY 27. THESE DRAWINGS & SPECIFICATIONS ARE THE PROPERTY & COPYRIGHT OF THE DESIGNER & SHALL NOT BE USED ON ANY OTHER

WORK EXCEPT BY AGREEMENT WITH THE DESIGNER.

28. THE DESIGNER HAS NO KNOWLEDGE OF & SHALL NOT BE HELD LIABLE FOR ANY ASBESTOS OR OTHER HAZARDOUS MATERIALS ON THE PROJECT SITE. PRIOR TO STARTING WORK, THE CONTRACTOR SHALL MAKE A GOOD FAITH EFFORT TO IDENTIFY ANY ASBESTOS OR OTHER HAZARDOUS MATERIALS. IF ASBESTOS OR OTHER HAZARDOUS MATERIALS ARE DISCOVERED PRIOR TO STARTING WORK, OR DURING DEMOLITION, STOP WORK IMMEDIATELY & CONTACT THE OWNER & DESIGNER FOR FURTHER INSTRUCTIONS BEFORE

PROCEEDING. 29. "TYPICAL" OR "TYP" MEANS THAT THIS ITEM IS VIRTUALLY IDENTICAL ACROSS SIMILAR CONDITIONS. "TYP." SHALL BE UNDERSTOOD TO MEAN "TYPICAL WHERE OCCURS" & SHALL NOT BE CONSIDERED AS WITHOUT EXCEPTION OR CONSIDERATION OF SPECIFIC CONDITIONS. IN CASE OF DISCREPANCY, CONSULT WITH DESIGNER BEFORE PROCEEDING

30. "SIMILAR" OR "SIM" MEANS COMPARABLE TO CHARACTERISTICS FOR THE CONDITION NOTED. VERIFY DIMENSIONS & ORIENTATION ON

31. "AS REQUIRED" MEANS AS REQUIRED BY REGULATORY REQUIREMENTS, BY REFERENCED STANDARDS, BY EXISTING CONDITIONS, BY GENERALLY ACCEPTED CONSTRUCTION PRACTICE, OR BY THE CONTRACT DOCUMENTS. 32. "ALIGN" MEANS ACCURATELY LOCATE FINISH FACES OF MATERIALS IN THE SAME PLANE

33. THE TERM "VERIFY" OR "V.I.F." SHALL BE UNDERSTOOD TO MEAN "VERIFY IN FIELD WITH DESIGNER" & REQUIRES THAT THE

CONTRACTOR CONFIRM INTENTION REGARDING NOTED CONDITION & PROCEED ONLY AFTER RECEIVING DESIGNER'S DIRECTION. 34. WHERE THE WORDS "OR EQUAL" OR WORDS OF SIMILAR INTENT FOLLOW A MATERIAL SPECIFICATION, THEY SHALL BE UNDERSTOOD TO REQUIRE SIGNED APPROVAL OF ANY DEVIATION TO SAID SPECIFICATION PRIOR TO CONTRACTOR'S ORDERING OR INSTALLATION OF SUCH PROPOSED EQUAL PRODUCT.

ABBREVIATIONS ABOVE MAX MAXIMUM AIR CONDITIONING MECH MECHANICAL ACOUS MFR MANUFACTURE **ACOUSTICAL** AD ADJ AREA DRAIN MIN MINIMUM **ADJUSTABLE** MISC **MISCELLANIOUS** ABOVE FINISH FLOOR MOUNTED MTD ALUMINUM MTL METAL

NO

OD

OPER

OPNG

OSCI

PLAM

PTD

RCP

REQD

RM

R0

RWL

SASM

SCHED

SECT

SED

SLD

SMD

SOG

SPD

SPEC

SPKR

SQ FT

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SSD

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STD

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STOR

SYM

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DEMO

EQUIV

EXT

FOC

FOW

GLU LAM

GLZ

GSM

GWB

HDWD

HDWE

HVAC

LAM

AVG

ALTERNATE

AVERAGE

BUILDING

BLOCKING

BOTTOM OF

BASEMENT

BETWEEN

BEYOND

CABINET

CEILING

CLOSET

CLEAR

COLUMN

CONCRETE

CONSTRUCTION

CONTINUOUS

COUNTERTOP

DOUBLE

DETAIL

DIAMETER

DIMENSION

DISTANCE

DRAWING

EXISTING

ELEVATION

ELECTRICAL

ELEVATOR

EQUIPMENT

EQUIVALENT

FINISH FLOOR

FINISH GRADE

FINISH(ED)

FIXTURE

FLASHING

FACE OF

FLUORESCENT

FACE OF CONCRETE

FACE OF FINISH

FACE OF STUD

FACE OF WALL

GAUGE, GAGE

GENERAL CONTRACTOR

GALVANIZED SHEET METAL

GYPSUM WALL BOARD

HEATING, VENTILATING,

AIR CONDITIONING

HOT WATER HEATER

INSIDE DIAMETER

INFORMATION

INTERIOR

LAMINATED

LAVATORY

LONGITUDINAL

POUND

LINEAR

GROUND FAULT INTERRUPT TEMP

GARBAGE DISPOSAL

GLASS OR GLAZING

GLUE LAMINATED

GLAZING

HOSE BIB

HARDWOOD

HARDWARE

HOLLOW METAI

HORIZONTAL

HOT WATER

HEAD

HOUR

HEIGHT

GALVANIZED

FOOT, FEET

FOOTING

FLOOR

EXTERIOR

DOWN

BUILDING PAPER

BUILT UP ROOF

CONTROL JOINT

CONCRETE MASONRY UNIT

DEMOLISH, DEMOLITION

DISPENSER, DISPOSAL

CENTER LINE

BOTTOM

BLOCK

APPROXIMATE(LY

ARCHITECT(URAL)

NOT APPLICABLE NOT IN CONTRACT NUMBER NOMINAL NOT TO SCALE

ON CENTER OUTSIDE DIAMETER OPERABLE OPENING OPPOSITE OWNER SUPPLIED, CONTRACTOR INSTALLED

PERFORATED PERPENDICULAR PLATE PLASTIC LAMINATE PLYW00D PRE-FABRICATE **PROPERTY** POUNDS PER SQUARE INCH PRESSURE TREATED

RETURN AIR RADIUS REFLECTED CEILING PLAN RECESSED REFRIGERATOR REQUIRED REVISION ROOM ROUGH OPENING RAIN WATER LEADER

PAINT(ED)

SELF-ADHERING SHEET MEMBRANE SEE CIVIL DRAWINGS SCHEDULE **SMOKE DETECTOR** SECTION SEE ELECTRICAL DRAWINGS SQUARE FOOT/FEET SHEET, SHEETING SHOWER SIMILAR SLIDING/SLIDER SEE LANDSCAPE DRAWINGS SEE MECHANICAL DRAWINGS SLAB ON GRADE SEE PLUMBING DRAWINGS SPECIFICATION(S) SPEAKER SQUARE SQUARE FOOT

SQUARE INCH SEE STRUCTURAL DRAWINGS STAINLESS STEEL STREET STANDARD STEEL STORAGE STRUCTURAL SYMMETRICAL

TOP AND BOTTOM TONGUE AND GROOVE TELEPHONE **TEMPERED** THICK(NESS) THROUGH TOP OF TOP OF CONCRETE TOP OF PLATE TOP OF SLAB TOP OF WALL

TELEVISION

TYPICAL UNDERWRITER'S LABORATOR' UNLESS OTHERWISE NOTED

VARIES VAPOR BARRIER VERTICAL VERTICAL GRAIN VERIFY IN FIELD VOLUME WASHER WITH WITHOUT

WATER CLOSET

WEATHERPROOF

WOOD


WINDOW

WEIGHT

SYMBOLS DRAWING NUMBER GRID BUBBLE SHEET NUMBER A3.4 EXTERIOR ELEVATION DRAWING NUMBER SEE SCHEDULE A3.4 SHEET NUMBER DRAWING NUMBER SEE SCHEDULE A3.4 SHEET NUMBER INTERIOR ELEVATION REVISION MARKER DRAWING NUMBER SHEET NUMBER AREA OF REVISION DATUM POINT

EXISTING PHOTOS OF HOUSE

VIEWS OF SOUTH SIDE YARD

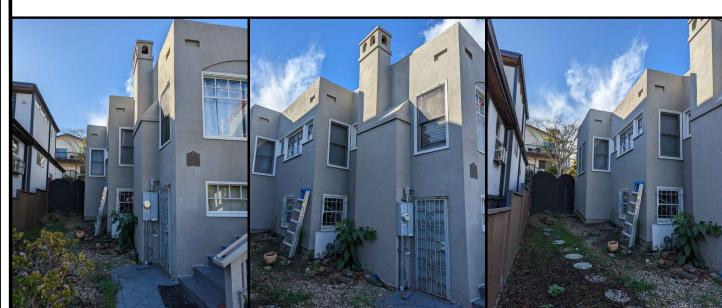

/IEW OF FRONT OF HOUSE

VIEWS OF SOUTH SIDE/ FRONT STAIRS/ PORCH





VIEWS OF NORTH SIDE/ PORCH FROM BACK YARD



PROJECT DESCRIPTION

ZONING/ BUILDING INFORMATION: PROJECT ADDRESS: 830 CERRITO STREET ASSESSOR'S PARCEL NUMBER: 66-2748-0 ZONING: R-1

TYPE OF CONSTRUCTION: V-B TYPE OF OCCUPANCY: R-3

PROPOSED GENERAL INFORMATION **EXISTING** IMPERVIOUS SURFACE: 44% 38% NARROWEST WIDTH OF DRIVEWAY: 17'-11" 17'-11" SITE REGULATIONS BY DISTRICT: **PROPOSED** REQUIREMENT **EXISTING** SETBACKS: FRONT (EAST) 11.86' SIDE (NORTH): 2.86' 2.86' 5' (10% OF AVERAGE OF LOT) SIDE (SOUTH): 7.48' 7.48' 5' (10% OF AVERAGE OF LOT) REAR (WEST) 46'-3" 20'-0" 44.35 5000 SF LOT SIZE: 5000 SF LOT COVERAGE (SEE A1.1) 28.7% 50% 25.7% Maximum Height: 17'-11" 22'-6" 28' MAX. **FLOOR AREA RATIO: EXISTING** PROPOSED **REQUIREMEN** GARAGE: COVERED PORCH INTERIOR STAIRS FIRST FLOOR SECOND FLOOR

DEDUCTIONS:

TOTAL COUNTED:

FLOOR AREA RATIO:

TOTAL AREA COUNTED ABOVE:

2'-9" LIFT TO HOME TO CONVERT EXISTING CRAWL SPACE/ BASEMENT TO HABITABLE SPACE WITH ADDITION OF PRIMARY BEDROOM, OFFICE AND STORAGE. NEW INTERNAL STAIRCASE, NEW ADDITION, NEW OPEN GREA⁻ ROOM WITH KITCHEN, DINING AND LIVING ROOM


2434

280

2674

280

55% (2750 MAX SF)

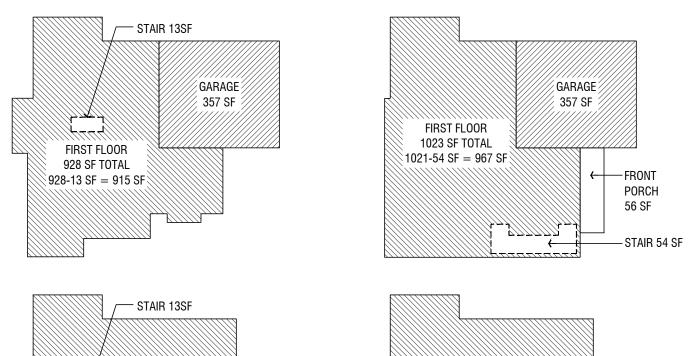

REMOVED AREA SECOND FLOOR 23 SF ----1242 SF TOTAL 1240-54 SF = 1186 SF SECOND FLOOR 1149 SF TOTAL 1149-13 SF = 1136 SF ADDITION 113 SF — PROPOSED FLOOR AREA GRAPHIC CALC.'S

SCALE: NTS , EXISTING FLOOR AREA GRAPHIC CALC.'S

BUILDING CODES

2019 CALIFORNIA RESIDENTIAL CODE (C.C.R., TITLE 24, PART 2.5) 2019 CALIFORNIA ELECTRICAL CODE (C.C.R., TITLE 24, PART 3)

2019 CALIFORNIA MECHANICAL CODE (C.C.R., TITLE 24, PART 4) 2019 CALIFORNIA PLUMBING CODE (C.C.R., TITLE 24, PART 5)

2019 CALIFORNIA ENERGY CODE (C.C.R., TITLE 24, PART 6) 2019 CALIFORNIA GREEN BUILDING STANDARDS CODE (C.C.R., TITLE 24, PART 11)

2019 CALIFORNIA HISTORICAL CODE (C.C.R., TITLE 24, PART 6)

DRAWING INDEX

A0.0 COVER SHEET A1.0 EXISTING & PROPOSED SITE/ ROOF PLANS

A1.1 LANDSCAPE PLAN & LOT COVERAGE DIAGRAMS

A2.0 EXISTING FLOOR PLANS A2.1 PROPOSED FLOOR PLANS

A3.0 EXISTING EXTERIOR ELEVATIONS

A3.1 EXISTING EXTERIOR ELEVATIONS A3.2 PROPOSED EXTERIOR ELEVATIONS

A3.3 PROPOSED EXTERIOR ELEVATIONS

A3.4 PROPOSED BUILDING SECTION &

PANORAMIC PHOTO STREET ELEVATION

A5.0 DOOR & WINDOW SCHEDULES C1 SITE SURVEY

PROJECT DIRECTORY

NICOLE WASHINGTON AND DREW ERICKSON NICOLE.L.WASHINGTON@GMAIL.COM DREW.T.ERICKSON@GMAIL.COM

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ANDREAS DEAK

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Principal: Amber Evans

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DESIGNER

PROJECT

RC HING Z Z Z S

A0.0

SHEET DATA

2022.11.11

PLANNING

1/4" = 1'-0"

SHEET TITLE

DESIGN REVIEW

COVER SHEET

22001


DATE:

JOB NO.:

PHASE


ISSUED:

SCALE:

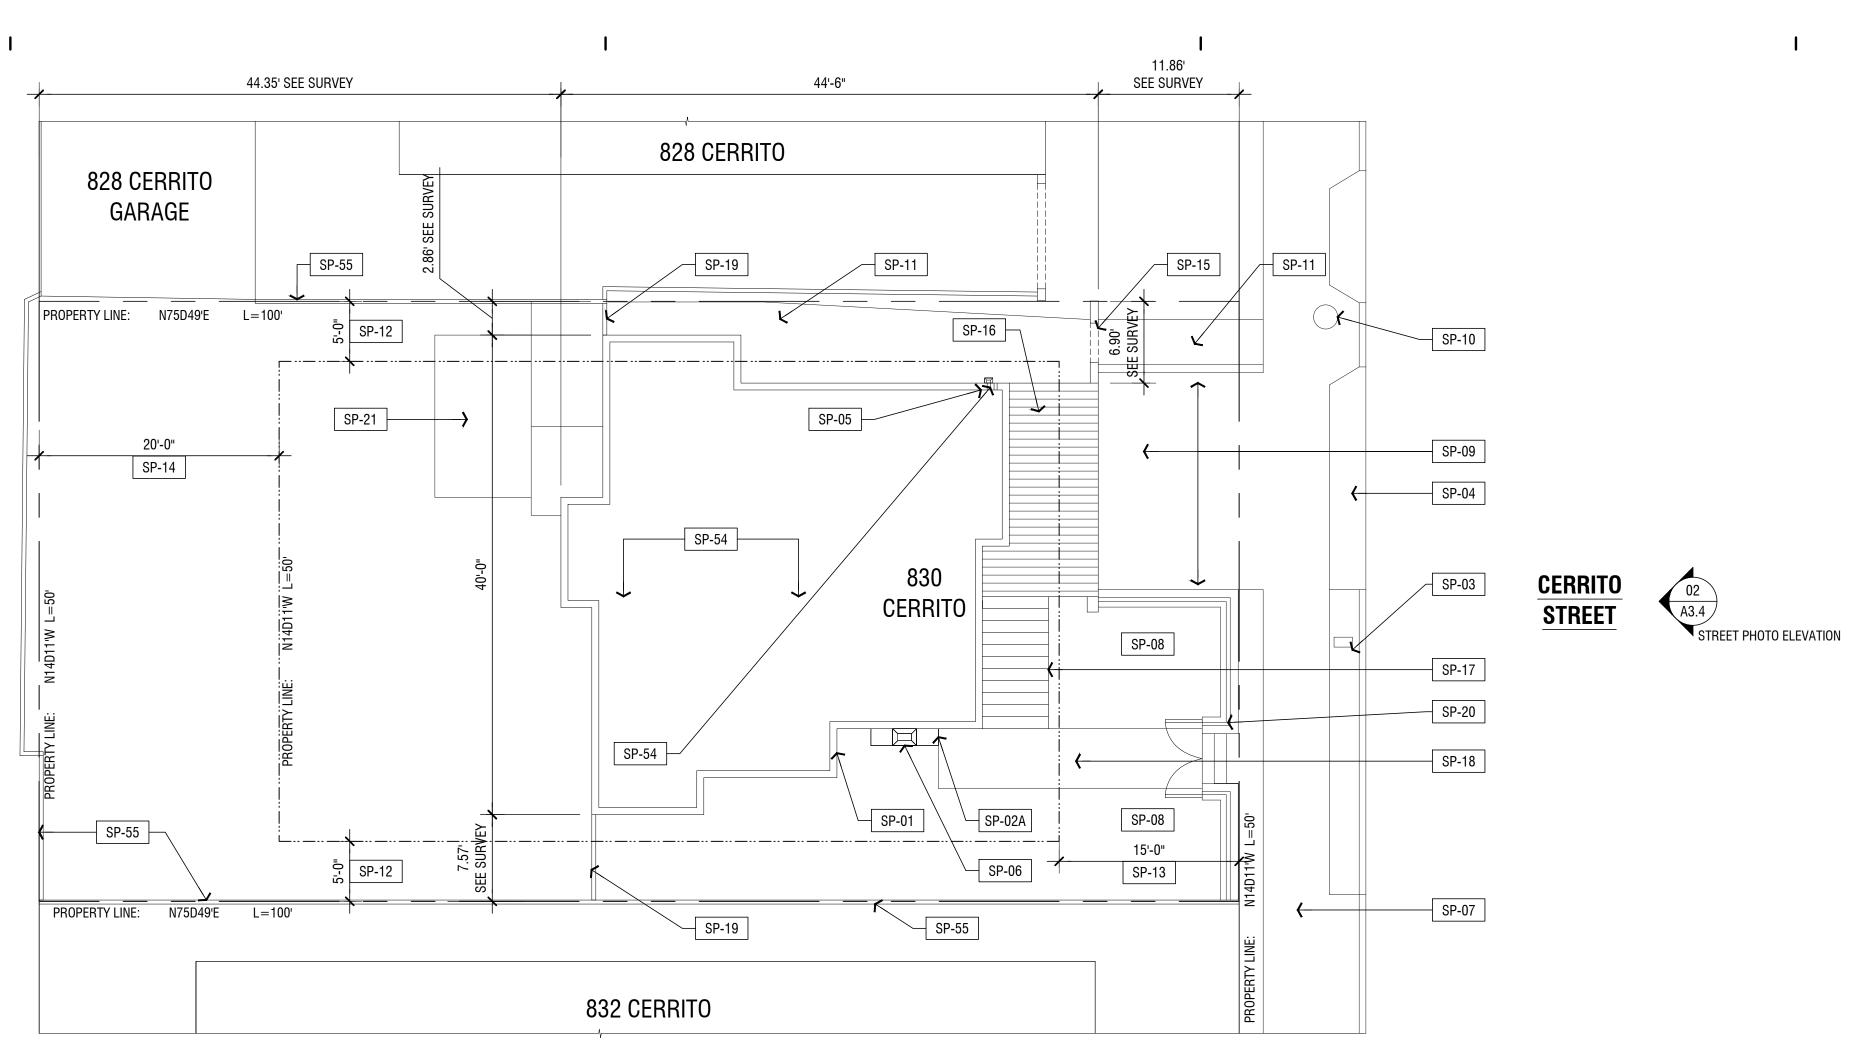

ACTUAL PROJECT NORTH NORTH

O1 EXISTING SITE/ROOF PLAN SCALE: 1/8"=1'-0"

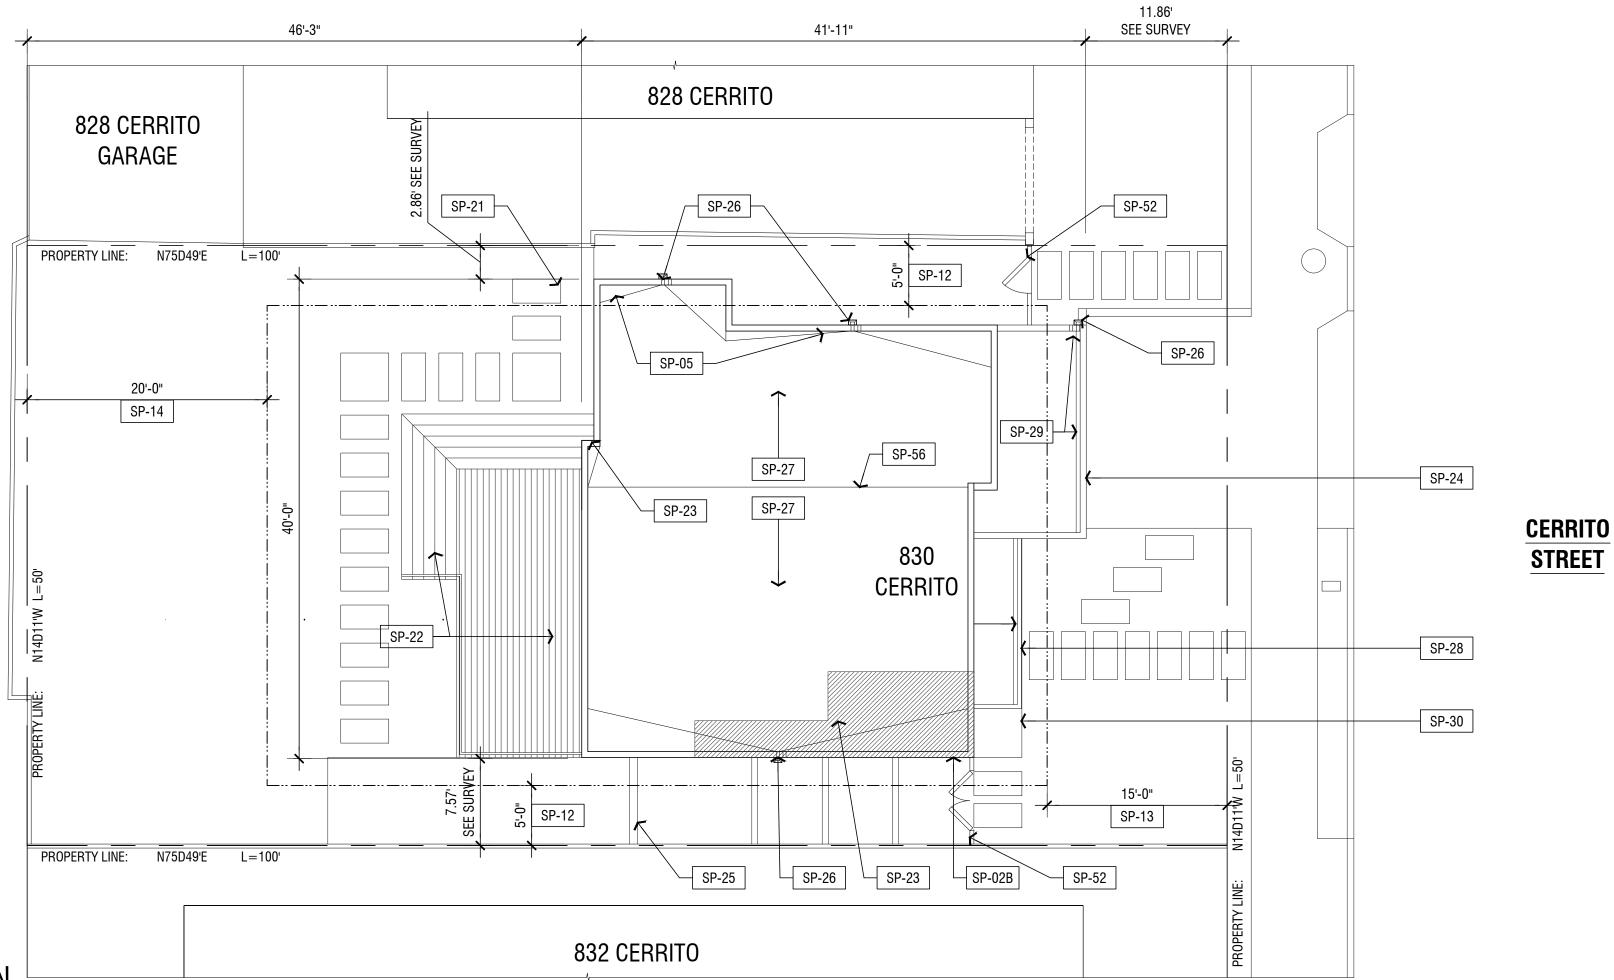



SP-01 (E) GAS METER LOCATION SP-02A (E) PGE METER LOCATION SP-02B (N) PGE METER LOCATION SP-03 (E) WATER METER SP-04 (E) CURB CUT (E) THRU WALL SCUPPER, OVERFLOW AND DOWNSPOUT TO BE SP-06 (E) CHIMNEY TO BE REMOVED SP-07 (E) SIDEWALK SP-08 (E) FRONT YARD LAWN (E) CONCRETE DRIVEWAY AND SIDE RETAINING WALLS TO REMAIN SP-10 (E) SEWER MANHOLE (E) SIDE YARD CONC. PATH TO BE REMOVED SIDE YARD SETBACK = SIDE YARD SETBACK 10% PER PLANNING CODE SP-13 FRONT YARD SETBACK SP-14 REAR YARD SETBACK (E) SIDE YARD STUCCO WALL / PASS THRU TO BE REMOVED. (E) TILED ROOF AND STUCCO COLUMNS TO BE REMOVED, SEE PROPOSED PLAN FOR COORDINATION (E) FRONT STAIRS TO BE REMOVED, SEE PROPOSED PLAN FOR SP-18 (E) FRONT CONCRETE PATH TO BE REMOVED (E) SIDE YARD FENCE/GATE TO BE REMOVED (E) FRONT YARD WOOD FENCE, GATE AND CONCRETE LOW RETAINING WALL/ STEPS TO BE REMOVED **ERICKSON** (E) REAR YARD CONCRETE SLAB ON GRADE TO BE REMOVED (N) DECK AND STEPS AT REAR YARD W/ 42° TALL GUARD (WD. POSTS AND STAINLESS STEEL CABLE RAILS) SP-23 AREA OF (N) ADDITION SHOWN HATCHED WASHINGTON- ERIC RESIDENCE 830 CERRITO STREE ALBANY, CALIFORNI, PARCEL # 66-2748-0 (N) TALLER PARAPET OVER ON T.O. (E) WALL AT THE GARAGE ROOF. (N) CONC. RETAINING WALL AT SIDE YARD, SEE EXTERIOR ELEVATIONS LOCATION OF (N) THRU WALL SCUPPER, OVERFLOW AND DOWNSPOUT SEE EXTERIOR ELEVATIONS (N) SLOPED BUILT UP ROOF AND CRICKETS, SLOPE TO THRU WALL SCUPPER/ OVERFLOW, SEE EXTERIOR ELEVATIONS (N) CANOPY AT FRONT DOOR, SLOPE BUILT UP ROOF AT CANOPY TO (N) SLOPED BUILT UP ROOF , SLOPE GUTTER, GUTTER TO SLOPE TO THRU WALL SCUPPER/ OVERFLOW SP-30 (N) CONC. SLAB ON GRADE AT ENTRY (N) GROUND COVER RUSCHIA NANA (N) PERENNIAL ANIGOZANTHOS (KANGAROO PAW) (N) FOUNTAIN GRASS SHRUB - PENNISETUM ORIENTALE 'KARLEY ROSE' (N) FOUNTAIN GRASS SHRUB - FESTUCA GLAUCA 'ELIJAH BLUE' (BLUE (N) PERENNIAL PHORMIUM 'AMAZING RED' (NEW ZEALAND FLAX) (N) PERENNIAL - LAVANDULA X INTERMEDIA 'PHENOMENAL' (LAVENDER) (N) GRASS - OPHIOPOGON PLANISCAPUS 'NIGRESCENS' (BLACK MONDO) (N) PERENNIAL - JASMINUM OFFICINALE (COMMON JASMINE) (N) SHRUB - LEUCADENDRON 'SAFARI SUNSHINE' (CONEBUSH) (N) SHRUB - BAMBUSA TEXTILIS VAR. GRACILIS "SLENDER WEAVERS" (N) TREE - BLOODGOOD JAPANESE MAPLE (N) TREE - MAJESTIC BEAUTY FRUITLESS OLIVE (N) TREE - CERCIS OCCIDENTALIS (WESTERN REDBUD) DATE: (N) TREE - TULIP POPLAR LIRIODENDRON TULIPIFERA JOB NO.: (N) SHRUB - FRAGRANT TEA OLIVE TREE OSMANTHUS FRAGRANS PHASE: SP-46 (N) TREE - DWARF FIG ISSUED: SP-47 (N) TREE - ZELKOVA SCALE: (N) 2'x3' BLUE STONE PAVERS (N) RIVERSTONE FLANKING AROUND PAVERS EXISTING/ (N) DECOMPOSED GRANITE AT SIDE YARD (N) WD. RAILROAD TIES AT SIDE YARD FOR STEPS/ SHORT RETAINING, GRADE TO LEVEL OUT BTWN TIES. PROPOSED (N) 6' TALL RDWD. GATE AND FENCE AT SIDE YARD. SITE & ROOF (E) ROOFING SLOPES FROM SOUTHWEST CORNER DOWN TO NORTHEAST CORNER. REMOVE (E) ROOFING AT WHOLE ROOF. **PLANS** SP-54 REMOVE (E) ROOF FRAMING SOUTH SP-55 (E) 6' TALL WD. FENCE TO REMAIN SP-56 (N) PARAPET OR HIGHPT OF ROOF AS REQ. BTWN BOTH SIDES OF ROOF.

SITE PLAN LEGEND 0' 5' 10' 15' 20'

SP-XX SITE PLAN KEY NOTE

SITE PLAN KEY NOTES

ACTUAL PROJECT NORTH

PROPOSED SITE/ROOF PLAN

SCALE: 1/8"=1'-0"

A1.0

SHEET DATA

2022.11.28

PLANNING

1/4" = 1'-0"

SHEET TITLE

DESIGN REVIEW

22001

DESIGNER

EVANS DESIGN STUDIO

Principal: Amber Evans

m.510-326-0548

PROJECT

www.evans-design-studio.com

EVANS DESIGN STUDIO www.evans-design-studio.com Principal: Amber Evans m.510-326-0548

SITE PLAN LEGEND 0' 5' 10' 15' 20

SP-02A (E) PGE METER LOCATION SP-02B (N) PGE METER LOCATION

(E) THRU WALL SCUPPER, OVERFLOW AND DOWNSPOUT TO BE

(E) CONCRETE DRIVEWAY AND SIDE RETAINING WALLS TO REMAIN

SP-12 | SIDE YARD SETBACK = SIDE YARD SETBACK 10% PER PLANNING CODE ____

(E) SIDE YARD STUCCO WALL / PASS THRU TO BE REMOVED.

(E) TILED ROOF AND STUCCO COLUMNS TO BE REMOVED, SEE

(E) FRONT STAIRS TO BE REMOVED, SEE PROPOSED PLAN FOR

(E) FRONT YARD WOOD FENCE, GATE AND CONCRETE LOW RETAINING

(N) DECK AND STEPS AT REAR YARD W/ 42° TALL GUARD (WD. POSTS AND STAINLESS STEEL CABLE RAILS)

(N) TALLER PARAPET OVER ON T.O. (E) WALL AT THE GARAGE ROOF.

(N) CONC. RETAINING WALL AT SIDE YARD, SEE EXTERIOR ELEVATIONS

LOCATION OF (N) THRU WALL SCUPPER, OVERFLOW AND DOWNSPOUT

(N) SLOPED BUILT UP ROOF AND CRICKETS, SLOPE TO THRU WALL

(N) CANOPY AT FRONT DOOR, SLOPE BUILT UP ROOF AT CANOPY TO

(N) SLOPED BUILT UP ROOF , SLOPE GUTTER, GUTTER TO SLOPE TO

(N) FOUNTAIN GRASS SHRUB - PENNISETUM ORIENTALE 'KARLEY ROSE'

(N) FOUNTAIN GRASS SHRUB - FESTUCA GLAUCA 'ELIJAH BLUE' (BLUE

(N) PERENNIAL - LAVANDULA X INTERMEDIA 'PHENOMENAL' (LAVENDER)

(N) GRASS - OPHIOPOGON PLANISCAPUS 'NIGRESCENS' (BLACK MONDO)

(N) PERENNIAL PHORMIUM 'AMAZING RED' (NEW ZEALAND FLAX)

(N) PERENNIAL - JASMINUM OFFICINALE (COMMON JASMINE)

(N) SHRUB - LEUCADENDRON 'SAFARI SUNSHINE' (CONEBUSH)

(N) TREE - BLOODGOOD JAPANESE MAPLE

(N) DECOMPOSED GRANITE AT SIDE YARD

(N) 6' TALL RDWD. GATE AND FENCE AT SIDE YARD.

GRADE TO LEVEL OUT BTWN TIES.

REMOVE (E) ROOF FRAMING SOUTH

SP-54

(N) TREE - MAJESTIC BEAUTY FRUITLESS OLIVE

(N) TREE - CERCIS OCCIDENTALIS (WESTERN REDBUD)

(N) TREE - TULIP POPLAR LIRIODENDRON TULIPIFERA

(N) SHRUB - FRAGRANT TEA OLIVE TREE OSMANTHUS FRAGRANS

(N) SHRUB - BAMBUSA TEXTILIS VAR. GRACILIS "SLENDER WEAVERS"

SCUPPER/ OVERFLOW, SEE EXTERIOR ELEVATIONS

(E) REAR YARD CONCRETE SLAB ON GRADE TO BE REMOVED

SP-XX SITE PLAN KEY NOTE

SP-03 (E) WATER METER

SP-04 (E) CURB CUT

SP-07 (E) SIDEWALK

SP-10 (E) SEWER MANHOLE

SP-14 REAR YARD SETBACK

COORDINATION

SP-08

SP-23

SP-30

SITE PLAN KEY NOTES

SP-01 (E) GAS METER LOCATION

SP-06 (E) CHIMNEY TO BE REMOVED

(E) FRONT YARD LAWN

FRONT YARD SETBACK

SP-11 (E) SIDE YARD CONC. PATH TO BE REMOVED

PROPOSED PLAN FOR COORDINATION

(E) SIDE YARD FENCE/GATE TO BE REMOVED

AREA OF (N) ADDITION SHOWN HATCHED

SP-18 (E) FRONT CONCRETE PATH TO BE REMOVED

WALL/ STEPS TO BE REMOVED

SEE EXTERIOR ELEVATIONS

THRU WALL SCUPPER/ OVERFLOW

(N) CONC. SLAB ON GRADE AT ENTRY

(N) GROUND COVER RUSCHIA NANA

PROJECT

ERICKSON WASHINGTON
RESIDE
830 CERRITC
ALBANY, CAI

SHEET DATA

22001

2022.11.28 DATE: JOB NO.: **PLANNING** PHASE:

DESIGN REVIEW ISSUED: 1/4" = 1'-0" SCALE:

SHEET TITLE LANDSCAPE

PLAN & LOT COV./ **IMPERVIOUS**


(E) 6' TALL WD. FENCE TO REMAIN


(E) ROOFING SLOPES FROM SOUTHWEST CORNER DOWN TO NORTHEAST CORNER. REMOVE (E) ROOFING AT WHOLE ROOF.


(N) PARAPET OR HIGHPT OF ROOF AS REQ. BTWN BOTH SIDES OF ROOF.

PROPOSED LOT COVERAGE/ IMPERVIOUS SURFACE

SCALE: 1/8"=1'-0"

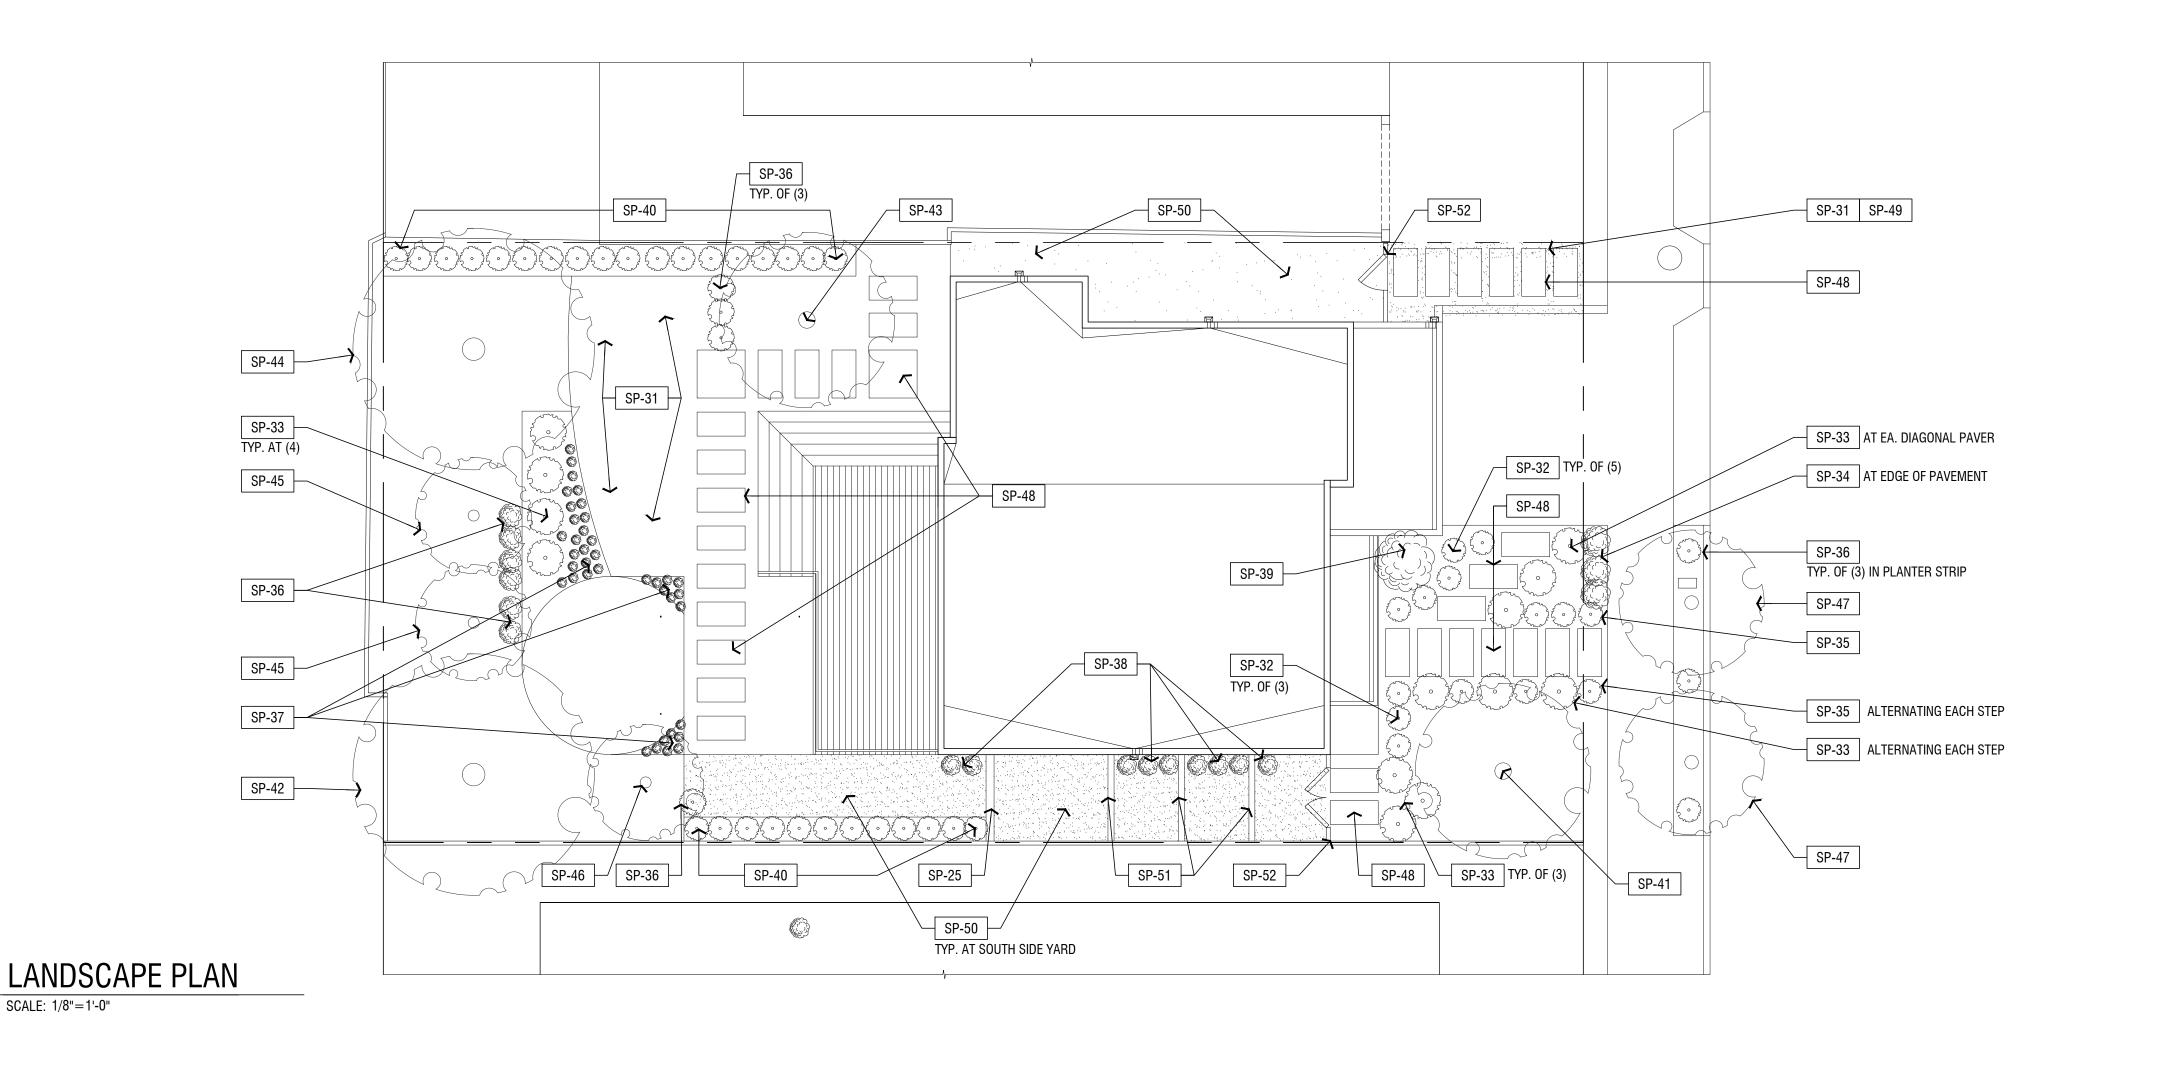

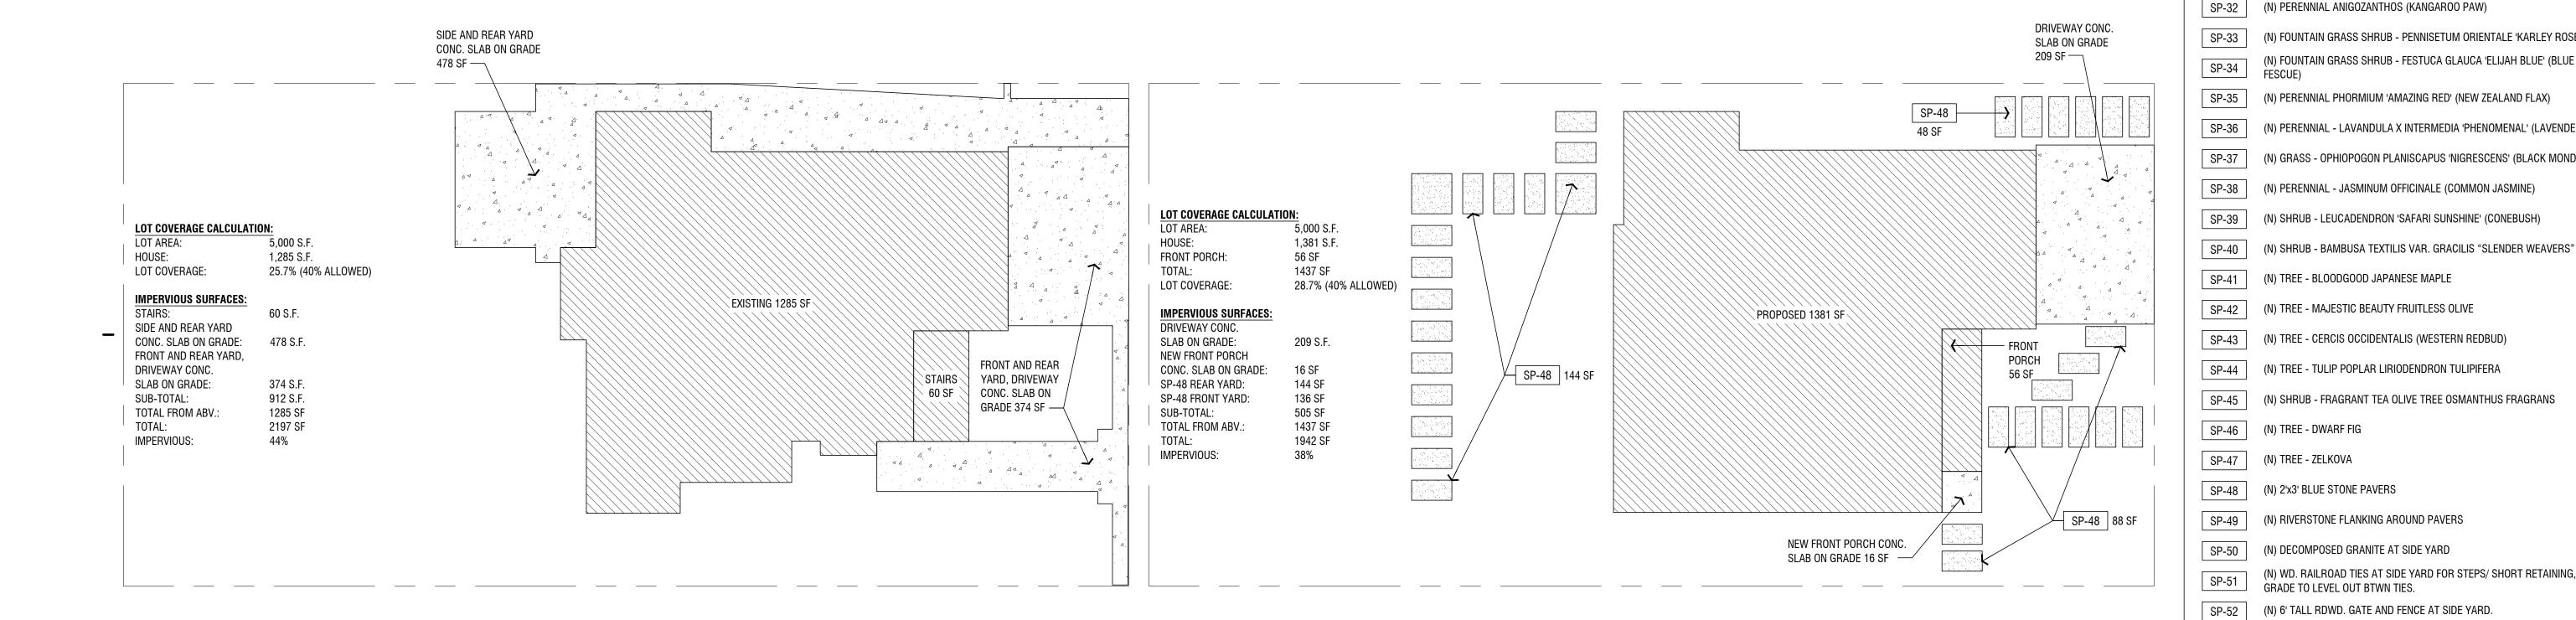

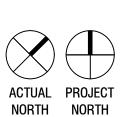

NORTH NORTH


EXISTING LOT COVERAGE/ IMPERVIOUS SURFACE

SCALE: 1/8"=1'-0"

ACTUAL PROJECT

NORTH NORTH

A1.1

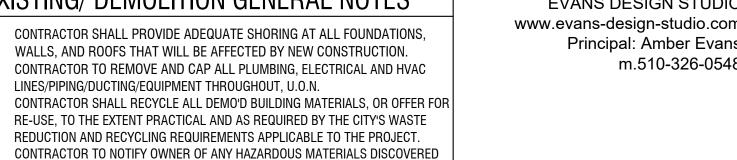

EXISTING/ DEMO. FLOOR PLAN LEGEND

(E) WD. FRAMED WALL TO REMAIN (E) ITEMS TO REMAIN

5. V.I.F. ALL EXISTING DIMENSIONS

DEP-11

DEP-15

02 A3.0

DEP-11

DEP-XX DEMOLITION EXISTING PLAN KEY NOTE

EXISTING/ DEMOLITION PLAN KEY NOTES

DEP-02 (E) WINDOW AND PTD. WD. TRIM TO BE REMOVED REMOVE (E) WALL, SEE PROPOSED PLAN. DEP-04 (E) DOOR AND PTD. WD. TRIM TO BE REMOVED (E) CONC. SLAB ON GRADE TO BE REMOVED, SEE SITE PLANS (E) CONC. RETAINING WALL AT 1ST FLOOR TO BE REPLACED IN (E) LOCATION, SEE PROPOSED PLAN REMOVE (E) COLUMNS AT FIRST FLOOR, SEE PROPOSED PLAN FOR NEW INTERIOR LAYOUT DEP-08 REMOVE (E) ROOF AND WALL/ COLUMNS AT PORCH ABOVE GARAGE

REMOVE COLUMNS AND WALL IN GARAGE

DEP-10 REMOVE EXISTING CHIMNEY REMOVE (E) WING WALL/ PASS THROUGH ADJACENT TO GARAGE

DEP-12 REMOVE (E) INTERIOR WALLS AS REQUIRED FOR PROPOSED PLAN (E) FLOOR FRAMING TO REMAIN, FLOOR LEVEL TO BE LIFTED TO (N) LOCATION SHOWN ON PROPOSED PLANS.

DEP-14 REMOVE (E) INTERNAL STAIR TO FIRST FLOOR

DEP-15 REMOVE (E) GARAGE DOOR DEP-16 REMOVE (E) SLAB ON GRADE AT 1ST FLOOR

DEP-17 REMOVE FINISHES, FIXTURES AND APPLIANCES IN ROOM AS REQURED FOR PROPOSED WORK.

DEP-18 REMOVE (E) FRONT ENTRY STAIRS

_____DEP-01 DEP-02 DEP-02 (E) BEDROOM <u>(E)</u> <u>BATH</u> <u>ROOM</u> NO.2

DEP-17

DEP-12 DEP-02 (E)
BEDROOM
NO.1

DEP-17
DEP-12 DEP-04 <u>(E)</u> <u>HALL</u> DEP-08 02 A3.0 DEP-14 (E) LAUNDRY (E) CL. DEP-17 DEP-12 DEP-02 DEP-04 DEP-17 DEP-12 <u>(E) CL.</u> (E) HALL 7'-3½" DEP-13
(E) F.F. SECOND FLOOR REF. DEP-03 (E) LIVING
ROOM
DEP-17
DEP-12 DEP-02 (E) KITCHEN DEP-17 DEP-12 DEP-18 (E) DINING ROOM DEP-02 DEP-17 DEP-12 PROJECT ACTUAL NORTH DEP-05 DEP-17 (E) OFFICE DEP-03 02 EXISTING 2ND FLR.

SCALE: 1/4"=1'-0" DEP-03

44'-6"

A3.1

(E) STORAGE

0'-0" (E) F.F. FIRST FLOOR

DEP-02

29'-6"

DEP-02

(E) STORAGE

DEP-02

DEP-03

/─| DEP-09 |─

(E) GARAGE

-1'-0" (E) F.F. GARAGE

DEP-04

3'-6"

DEP-03

_____DEP-05

DEP-06 TYP.

DEP-02

DEP-06

PROJECT ACTUAL

NORTH NORTH

EXISTING 1ST FLR.

SCALE: 1/4"=1'-0"

11'-6"


DEP-02

DEP-16

DEP-14 —

DEP-07

A2.0

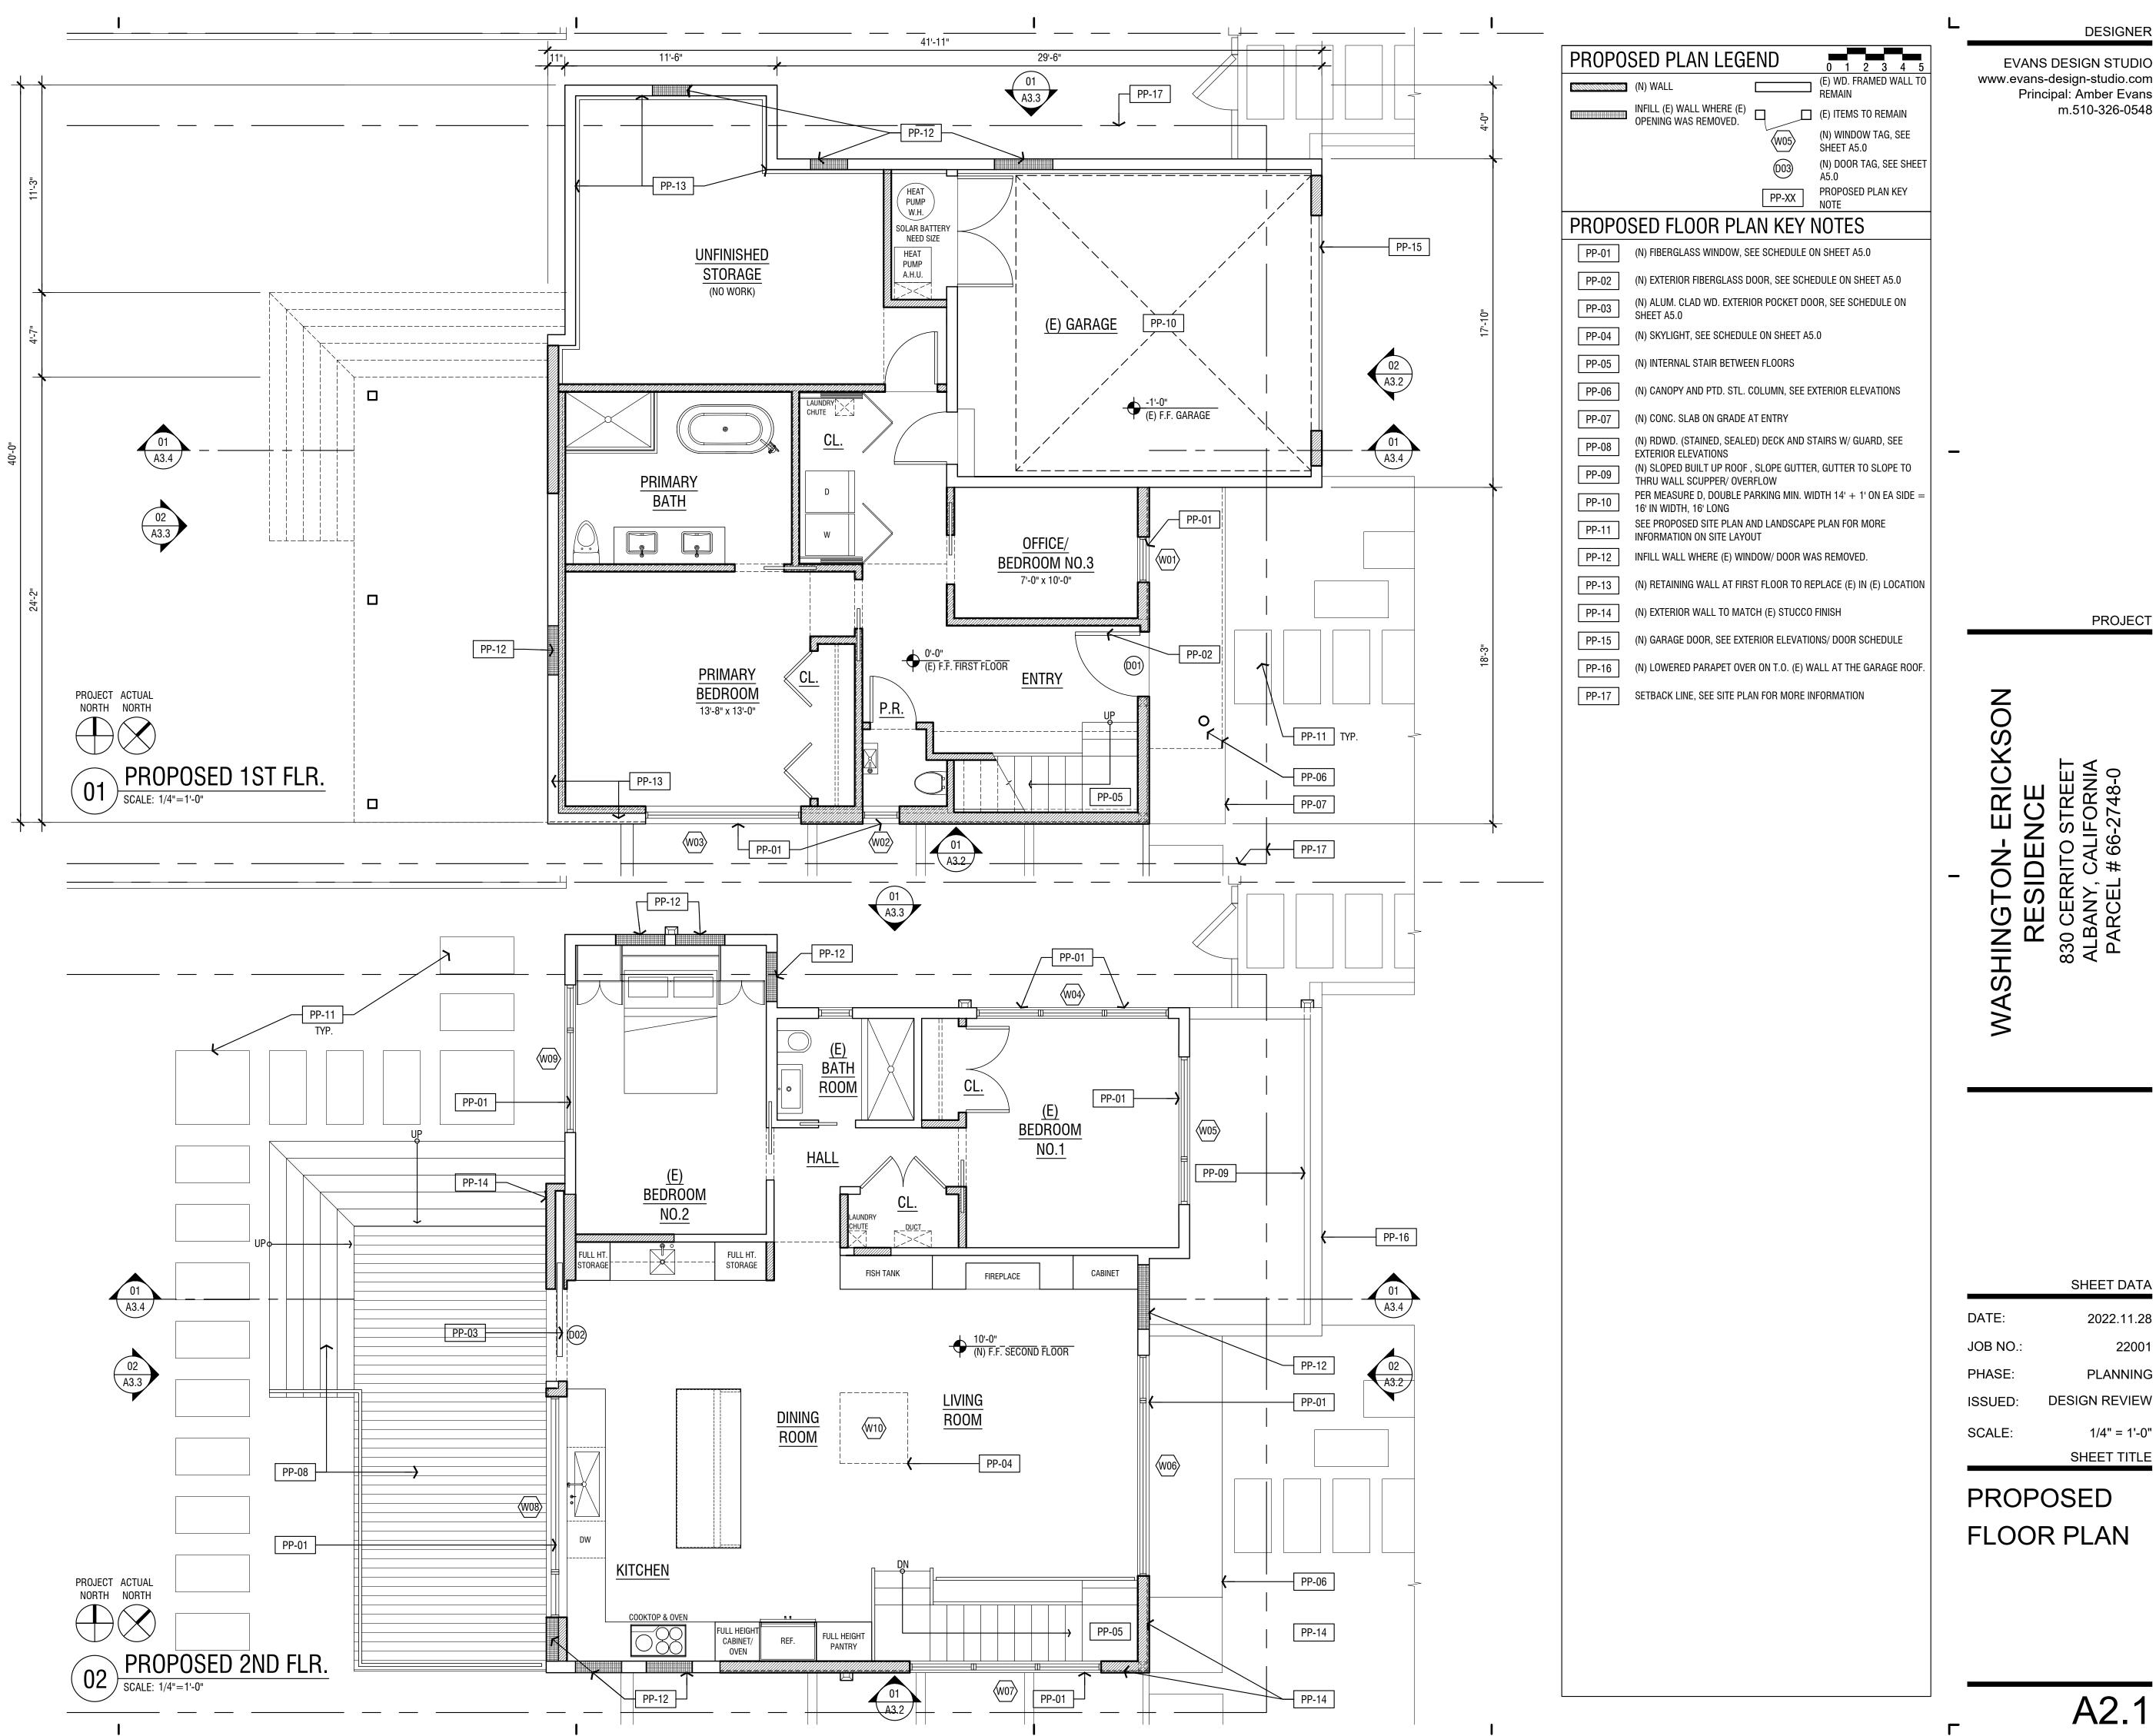

EVANS DESIGN STUDIO www.evans-design-studio.com Principal: Amber Evans

m.510-326-0548

2022.11.28 22001 PLANNING

1/4" = 1'-0"

www.evans-design-studio.com
Principal: Amber Evans
m.510-326-0548

EXISTING EXTERIOR ELEVATION LEGEND

EE-XX EXISTING ELEVATION KEY NOTE

EXISTING EXTERIOR ELEVATION KEY NOTES EE-01 (E) WINDOW AND PTD. WD. TRIM TO REMAIN (E) WINDOW AND PTD. WD. TRIM TO BE REMOVED REMOVE (E) WALL, SEE PROPOSED PLAN. (E) DOOR AND PTD. WD. TRIM TO BE REMOVED (E) TILED ROOF AND STUCCO COLUMNS TO BE REMOVED, SEE PROPOSED PLAN FOR COORDINATION EE-05 EE-06 REMOVE (E) GARAGE DOOR EE-07 REMOVE EXISTING CHIMNEY REMOVE (E) WING WALL/ PASS THROUGH ADJACENT TO GARAGE EE-09 (E) STUCCO EXTERIOR FINISH, TYP.

(E) CONC. SLAB ON GRADE TO BE REMOVED, SEE SITE PLANS.

(E) THRU WALL SCUPPER, OVERFLOW AND DOWNSPOUT TO BE REMOVED

EE-12 REMOVE (E) FRONT ENTRY STAIRS EE-13 SETBACK LINE, SEE SITE PLANS

EE-14 REMOVE (E) SIDE YARD FENCE/ GATE

PROJECT

SHEET DATA 2022.11.28


SHEET TITLE


22001 JOB NO.: PLANNING

DESIGN REVIEW 1/4" = 1'-0"

EXISTING EXTERIOR

ELEVATIONS

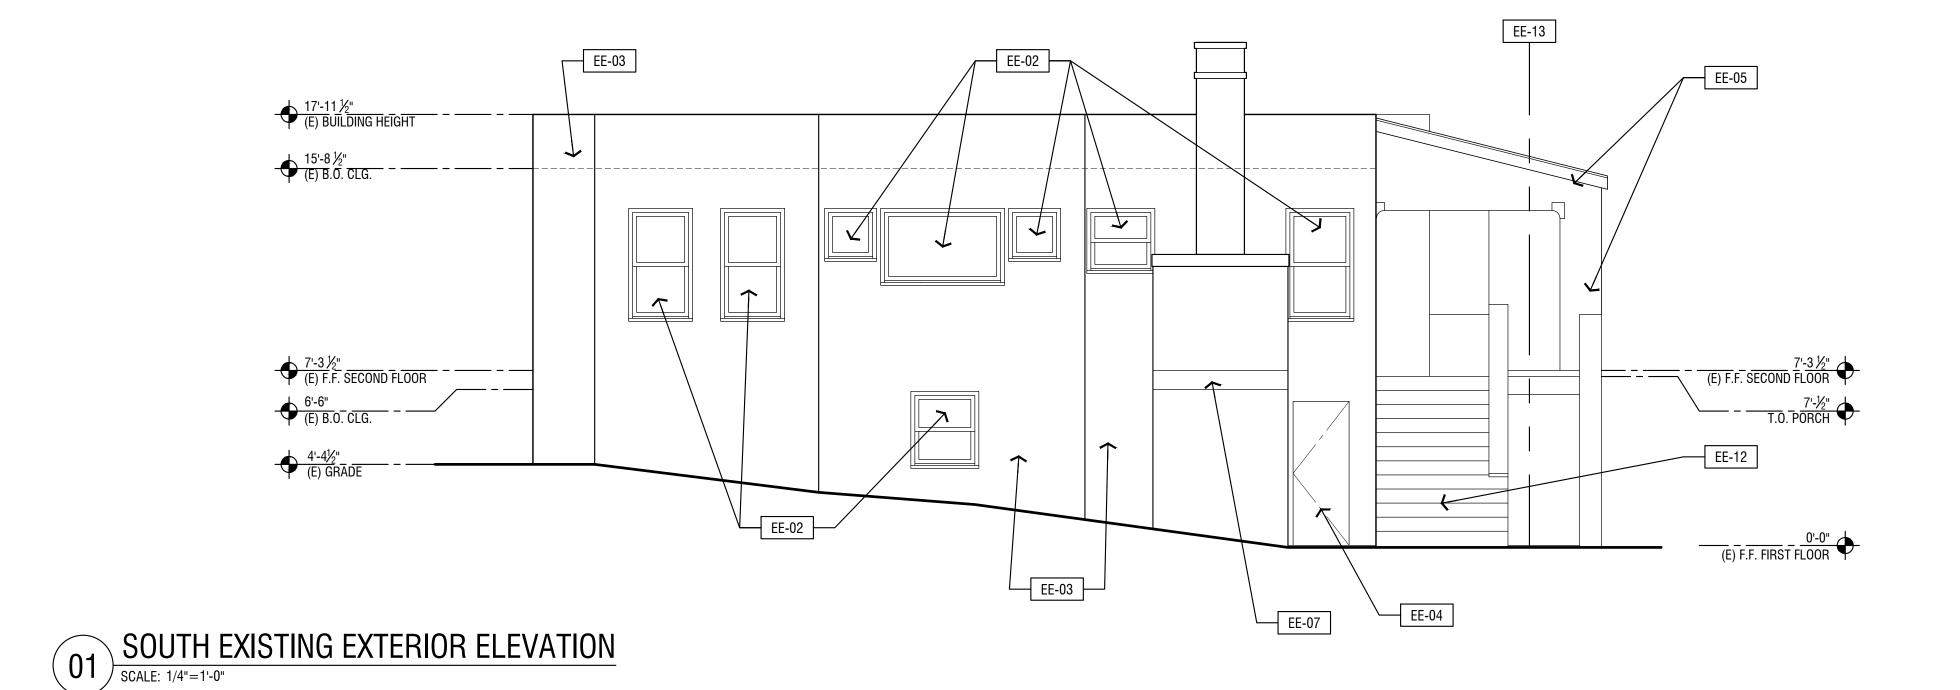

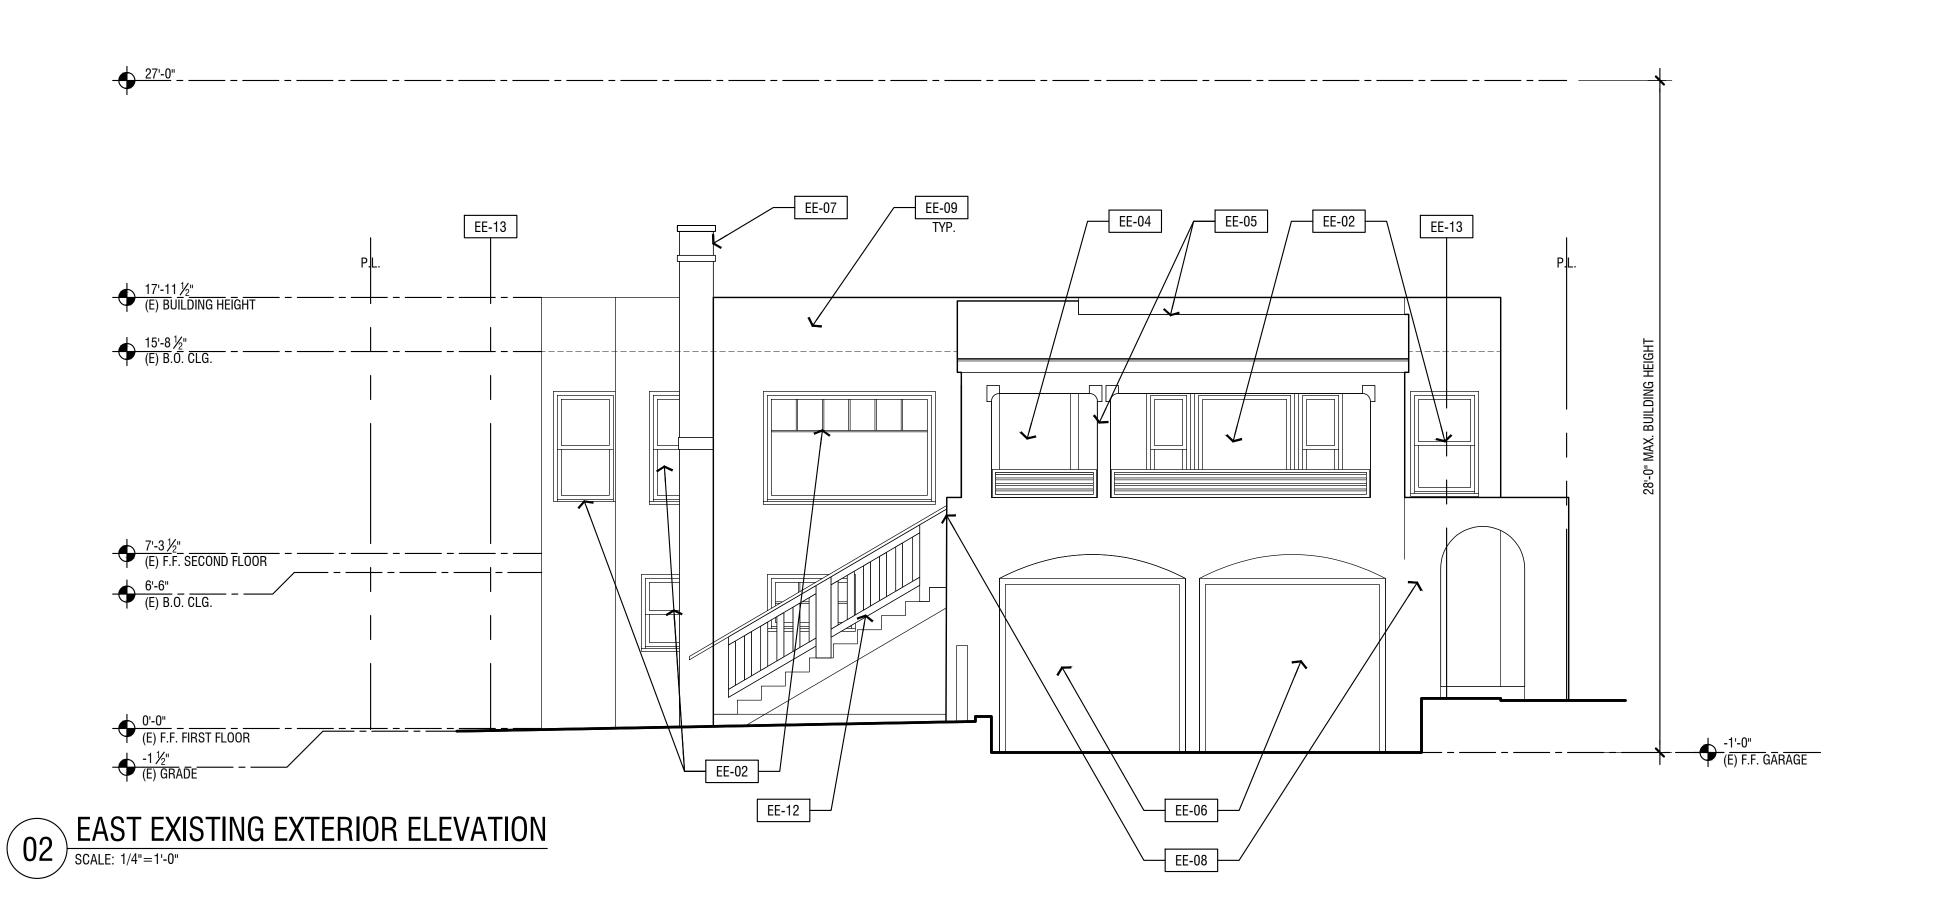

EE-XX

EE-05

EE-08

EE-12

EXISTING ELEVATION KEY NOTE

EXISTING EXTERIOR ELEVATION KEY NOTES

(E) WINDOW AND PTD. WD. TRIM TO BE REMOVED

(E) DOOR AND PTD. WD. TRIM TO BE REMOVED

(E) TILED ROOF AND STUCCO COLUMNS TO BE REMOVED, SEE PROPOSED PLAN FOR COORDINATION

REMOVE (E) WING WALL/ PASS THROUGH ADJACENT TO GARAGE

(E) CONC. SLAB ON GRADE TO BE REMOVED, SEE SITE PLANS.

(E) THRU WALL SCUPPER, OVERFLOW AND DOWNSPOUT TO BE REMOVED

REMOVE (E) WALL, SEE PROPOSED PLAN.

EE-01 (E) WINDOW AND PTD. WD. TRIM TO REMAIN

EE-06 REMOVE (E) GARAGE DOOR

EE-07 REMOVE EXISTING CHIMNEY

EE-09 (E) STUCCO EXTERIOR FINISH, TYP.

EE-13 SETBACK LINE, SEE SITE PLANS

EE-14 REMOVE (E) SIDE YARD FENCE/ GATE


REMOVE (E) FRONT ENTRY STAIRS


PROJECT

22001 JOB NO.: PLANNING DESIGN REVIEW

1/4" = 1'-0" SHEET TITLE

EXISTING EXTERIOR ELEVATIONS

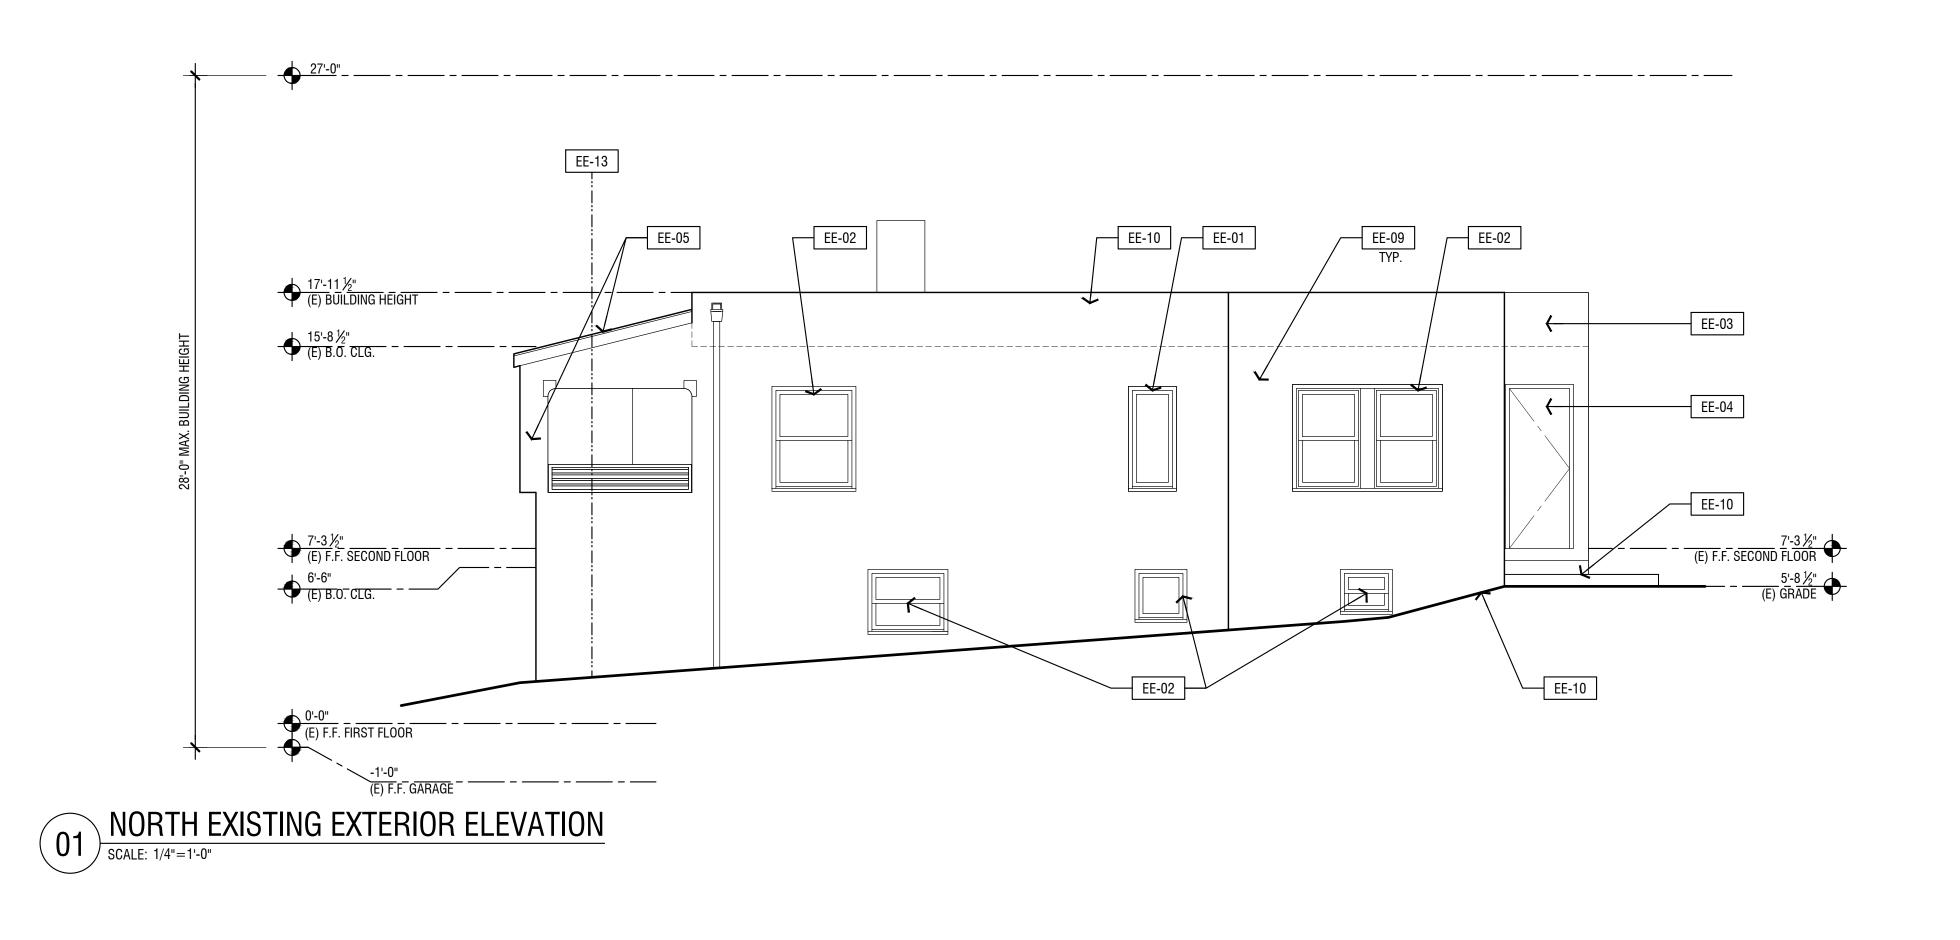

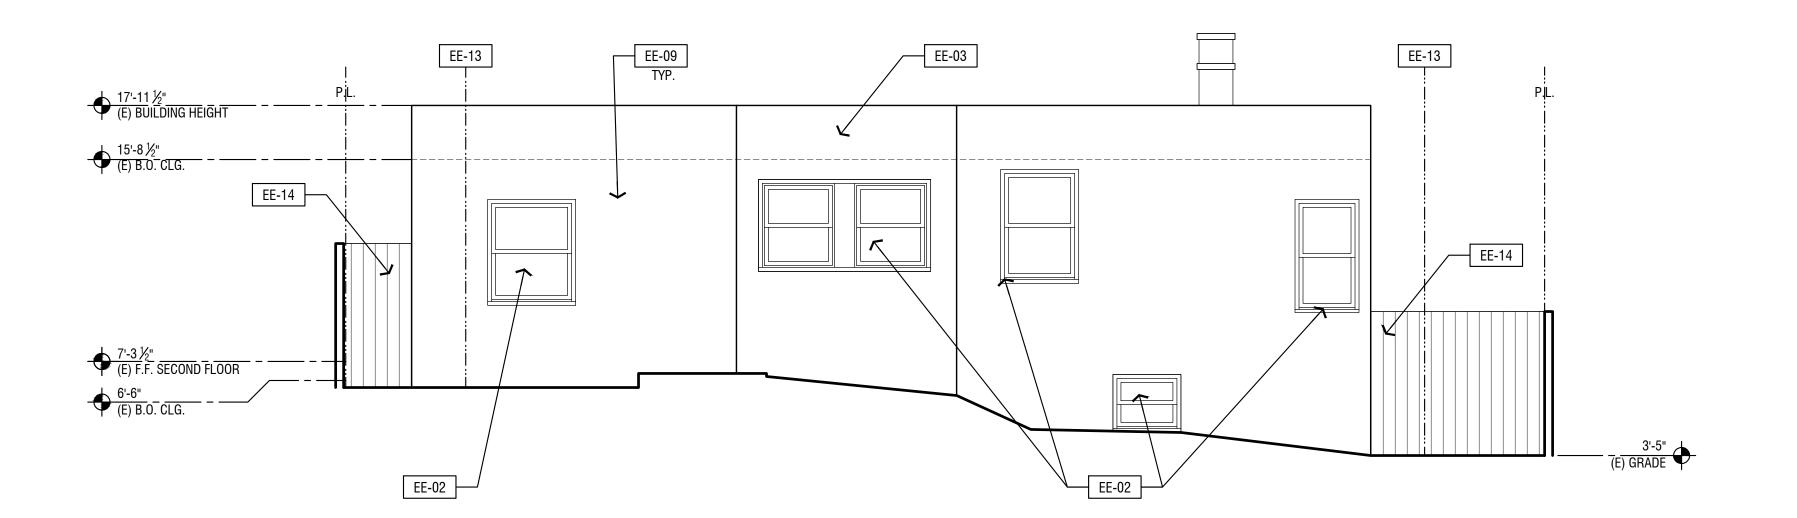

WEST EXISTING EXTERIOR ELEVATION

SCALE: 1/4"=1'-0"

PROPOSED EXT. ELEV./ SECTION LEGEND

PROPOSED EXT. ELEV./ SECTION KEY NOTES

(N) EXTERIOR FIBERGLASS DOOR, SEE SCHEDULE ON SHEET A5.0

(N) ALUM. CLAD WD. EXTERIOR POCKET DOOR, SEE SCHEDULE ON SHEET A5.0

(N) RDWD. (STAINED, SEALED) DECK AND STAIRS W/ GUARD - CABLE RAILS BTWN POSTS

(N) SLOPED BUILT UP ROOF , SLOPE GUTTER, GUTTER TO SLOPE TO THRU WALL SCUPPER/ OVERFLOW

(N) STAIRS AT DECK - (5) 11" TREADS, (6) EQ. RISERS (MAX. 7 $\frac{3}{4}$ ") W/ 1X REDWOOD, STAINED AND SEALED

(N) RETAINING WALL AT FIRST FLOOR TO REPLACE (E) IN (E) LOCATION

(N) LOWERED PARAPET OVER ON T.O. (E) WALL AT THE GARAGE ROOF.

(N) CANOPY AT FRONT DOOR, SLOPE BUILT UP ROOF AT CANOPY TO GUTTER BEHIND FASCIA.

(N) WD. RAILROAD TIES AT SIDE YARD FOR STEPS/ SHORT RETAINING, GRADE TO LEVEL OUT BTWN TIES.

(N) 1x4 STAINED AND SEALED CEDAR T&G SIDING UNDER CANOPY

(N) 6' TALL RDWD. GATE AND FENCE AT SIDE YARD.

(N) STUCCO FINISH TO MATCH EXISTING

PE-17 SETBACK LINE, SEE SITE PLAN FOR MORE INFORMATION

PE-21 (N) THRU WALL SCUPPER, OVERFLOW AND DOWNSPOUT, SEE SITE PLAN

PE-22 (E) 2ND FLR. RAISED TO (N) HEIGHT INDICATED (TOTAL RAISED IS 2'-9")

PE-23 (N) CONC. RETAINING WALL AT SIDE YARD, SEE EXTERIOR ELEVATIONS

PE-01 (N) FIBERGLASS WINDOW, SEE SCHEDULE ON SHEET A5.0

PE-05 (N) INTERNAL STAIR BETWEEN FLOORS SHOWN DASHED

PE-04 (N) PARAPET AT ROOF

PE-06 (N) PTD. STL. COLUMN

PE-07 (N) CONC. SLAB ON GRADE

PE-15 (N) PTD. GARAGE DOOR

PE-20 SETBACK, SEE SITE PLAN

PE-24 INTERIOR LAYOUT NOT SHOWN

PE-XX PROPOSED ELEVATION KEY NOTE

PROJECT

JOB NO.: 22001


PHASE: PLANNING

ISSUED: DESIGN REVIEW

SCALE: 1/4" = 1'-0"

SHEET TITLE

PROPOSED
EXTERIOR
ELEVATIONS

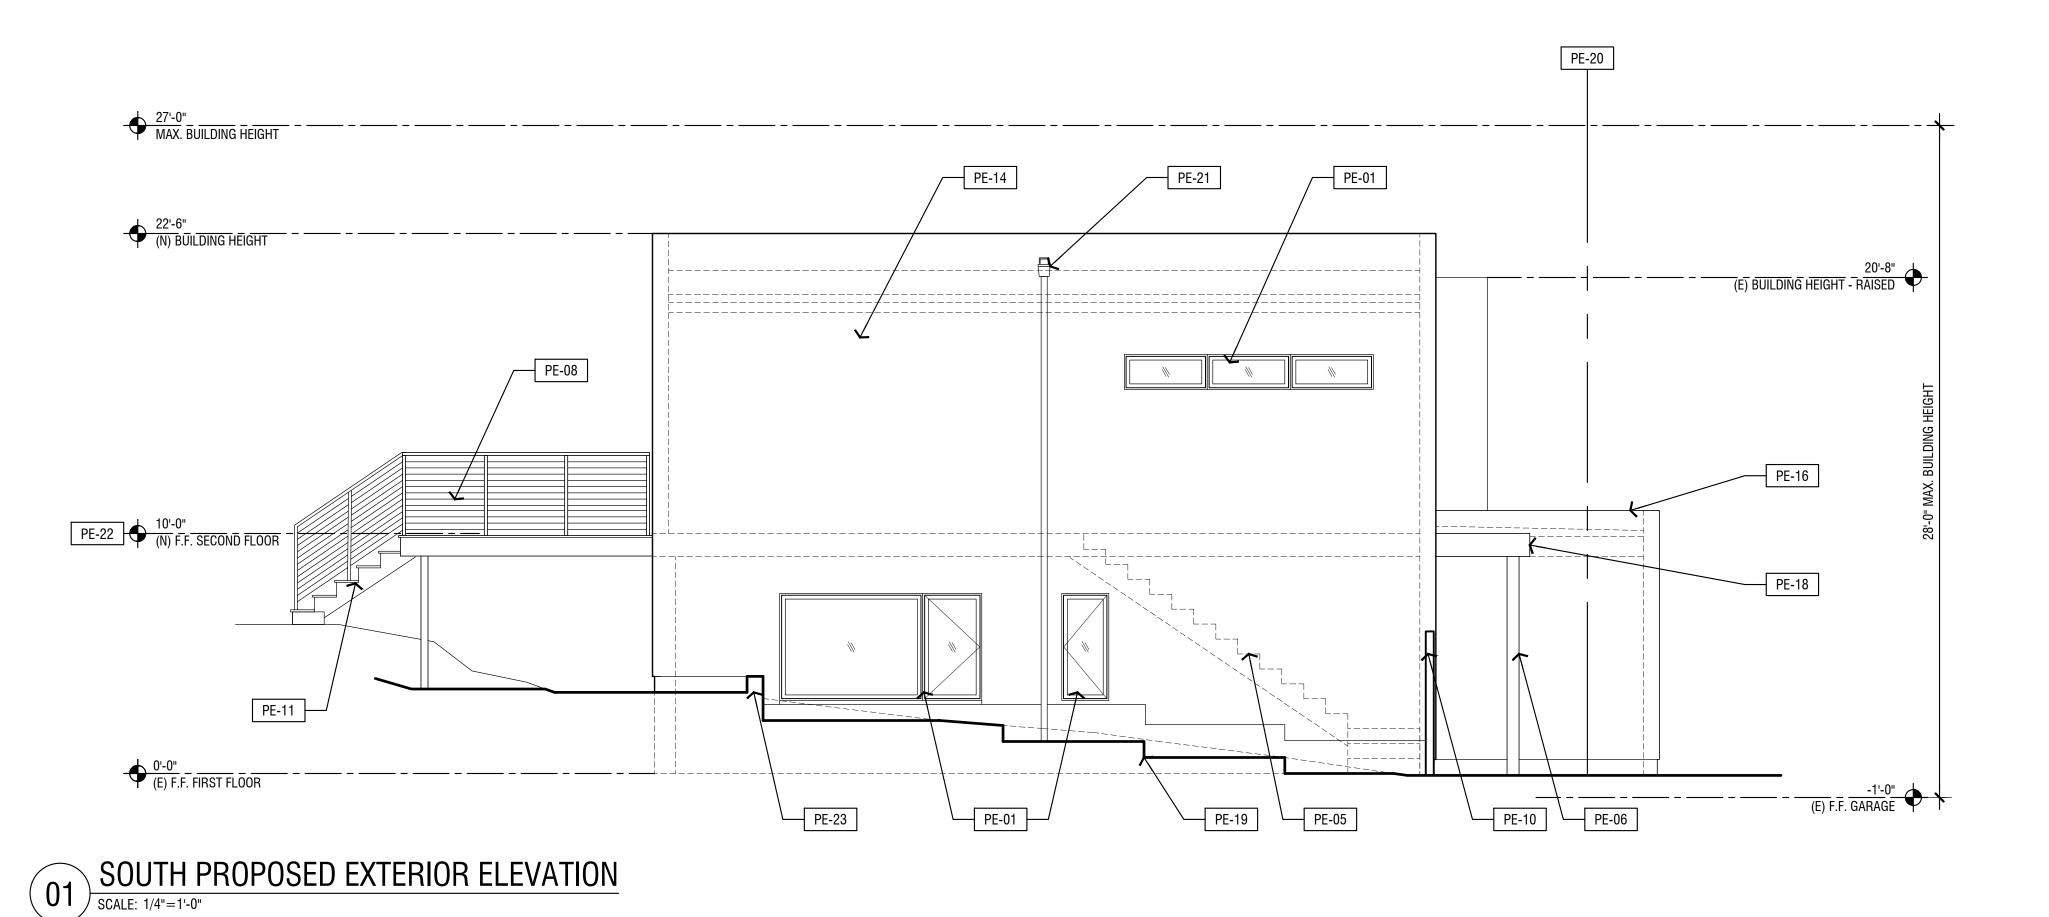


PE-20 MAX. BUILDING HEIGHT 22'-6"
(N) BUILDING HEIGHT - (E) BUILDING HEIGHT - RAISED (E) B.O. CLG. - RAISED PE-18 PE-22 10'-0" (N) F.F. SECOND FLOOR -PE-10 PE-10 0'-0" (E) F.F. FIRST FLOOR

-1 ½"
(E) GRADE PE-06 PE-02 PE-01 PE-15 PE-12 EAST PROPOSED EXTERIOR ELEVATION

SCALE: 1/4"=1'-0"

PROJECT

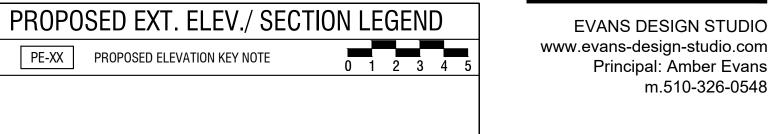

PROPOSED EXT. ELEV./ SECTION KEY NOTES

PE-01 (N) FIBERGLASS WINDOW, SEE SCHEDULE ON SHEET A5.0

(N) EXTERIOR FIBERGLASS DOOR, SEE SCHEDULE ON SHEET A5.0 (N) ALUM. CLAD WD. EXTERIOR POCKET DOOR, SEE SCHEDULE ON SHEET A5.0 PE-04 (N) PARAPET AT ROOF

PE-05 (N) INTERNAL STAIR BETWEEN FLOORS SHOWN DASHED PE-06 (N) PTD. STL. COLUMN

PE-07 (N) CONC. SLAB ON GRADE

(N) RDWD. (STAINED, SEALED) DECK AND STAIRS W/ GUARD - CABLE RAILS BTWN POSTS

(N) SLOPED BUILT UP ROOF , SLOPE GUTTER, GUTTER TO SLOPE TO THRU WALL SCUPPER/ OVERFLOW (N) 6' TALL RDWD. GATE AND FENCE AT SIDE YARD.

(N) STAIRS AT DECK - (5) 11" TREADS, (6) EQ. RISERS (MAX. 7 $\frac{3}{4}$ ") W/ 1X REDWOOD, STAINED AND SEALED

(N) 1x4 STAINED AND SEALED CEDAR T&G SIDING UNDER CANOPY (N) RETAINING WALL AT FIRST FLOOR TO REPLACE (E) IN (E) LOCATION

(N) STUCCO FINISH TO MATCH EXISTING

PE-15 (N) PTD. GARAGE DOOR

(N) LOWERED PARAPET OVER ON T.O. (E) WALL AT THE GARAGE ROOF.

PE-17 SETBACK LINE, SEE SITE PLAN FOR MORE INFORMATION

(N) CANOPY AT FRONT DOOR, SLOPE BUILT UP ROOF AT CANOPY TO GUTTER BEHIND FASCIA.

(N) WD. RAILROAD TIES AT SIDE YARD FOR STEPS/ SHORT RETAINING, GRADE TO LEVEL OUT BTWN TIES.


PE-20 SETBACK, SEE SITE PLAN


PE-21 (N) THRU WALL SCUPPER, OVERFLOW AND DOWNSPOUT, SEE SITE PLAN

PE-22 (E) 2ND FLR. RAISED TO (N) HEIGHT INDICATED (TOTAL RAISED IS 2'-9")

PE-23 (N) CONC. RETAINING WALL AT SIDE YARD, SEE EXTERIOR ELEVATIONS

PE-24 INTERIOR LAYOUT NOT SHOWN

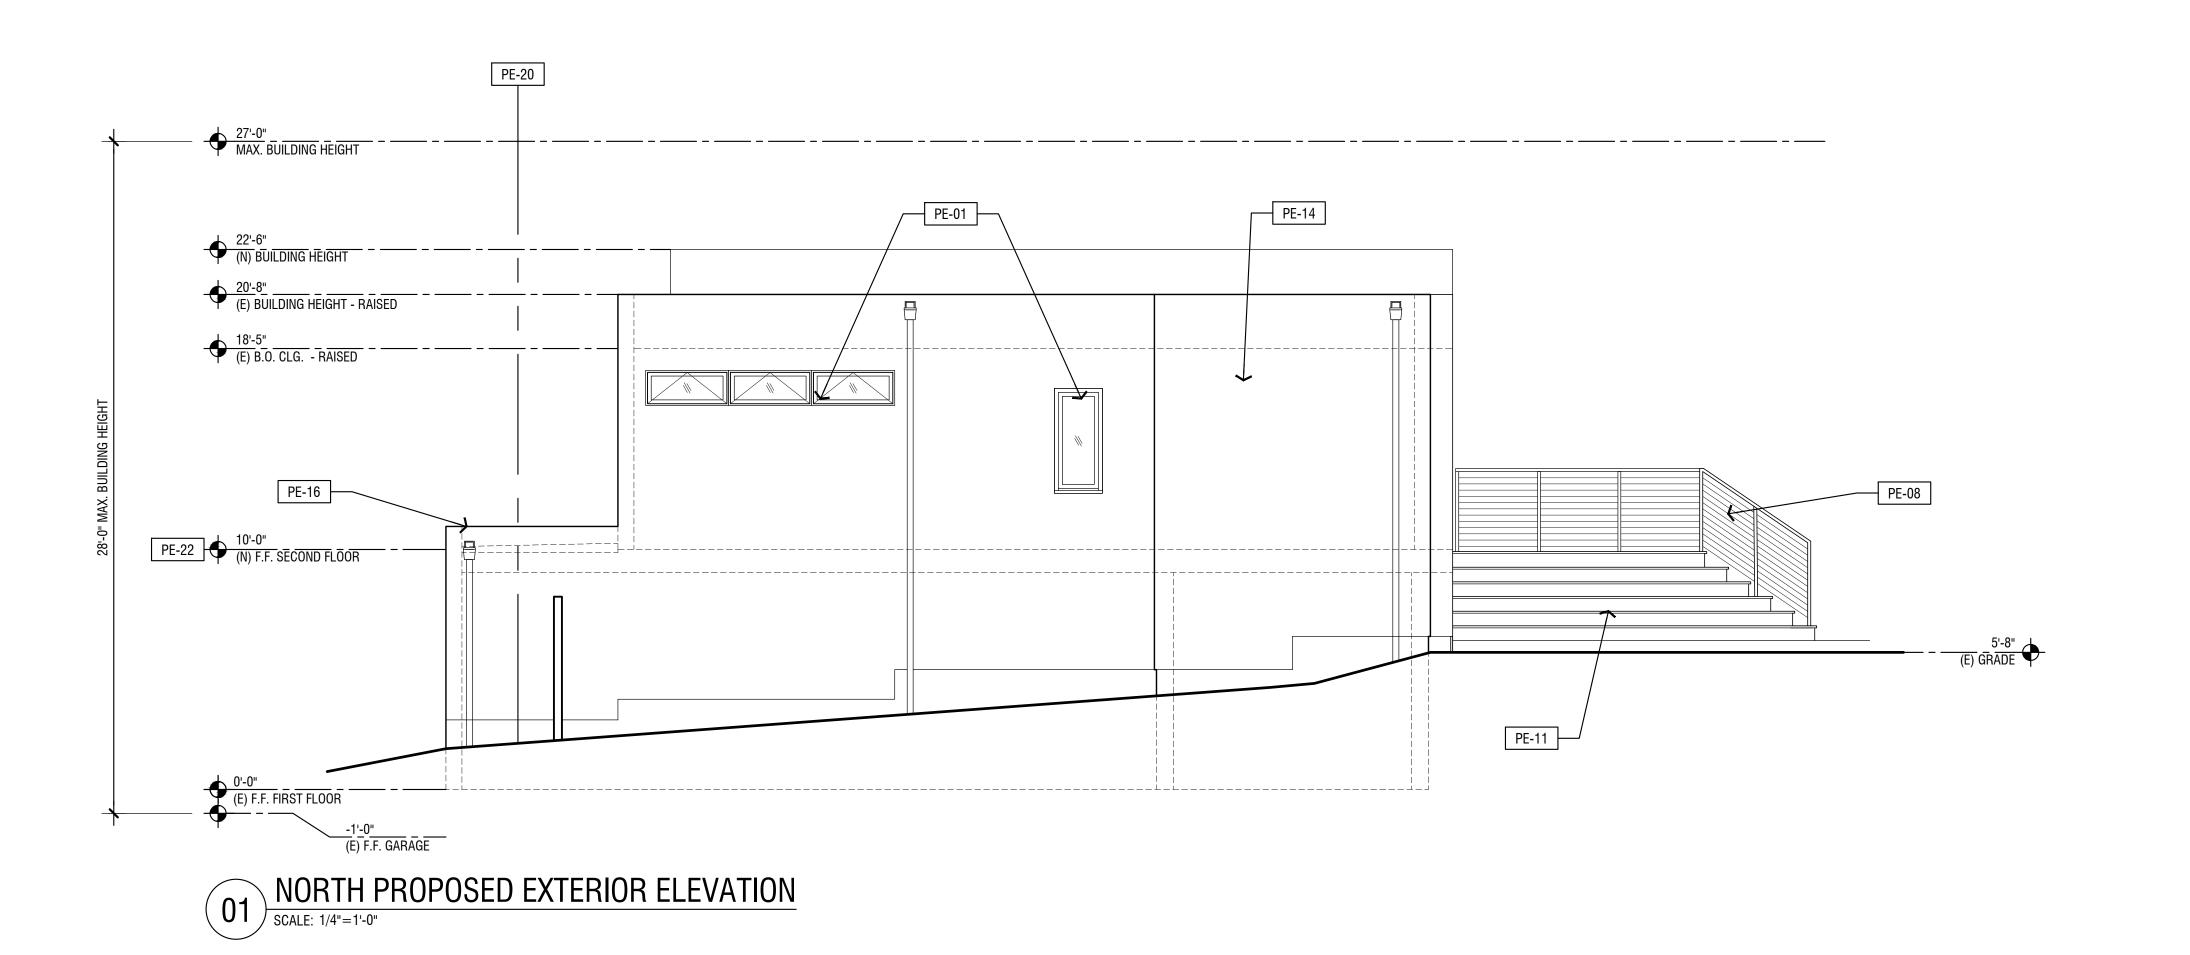

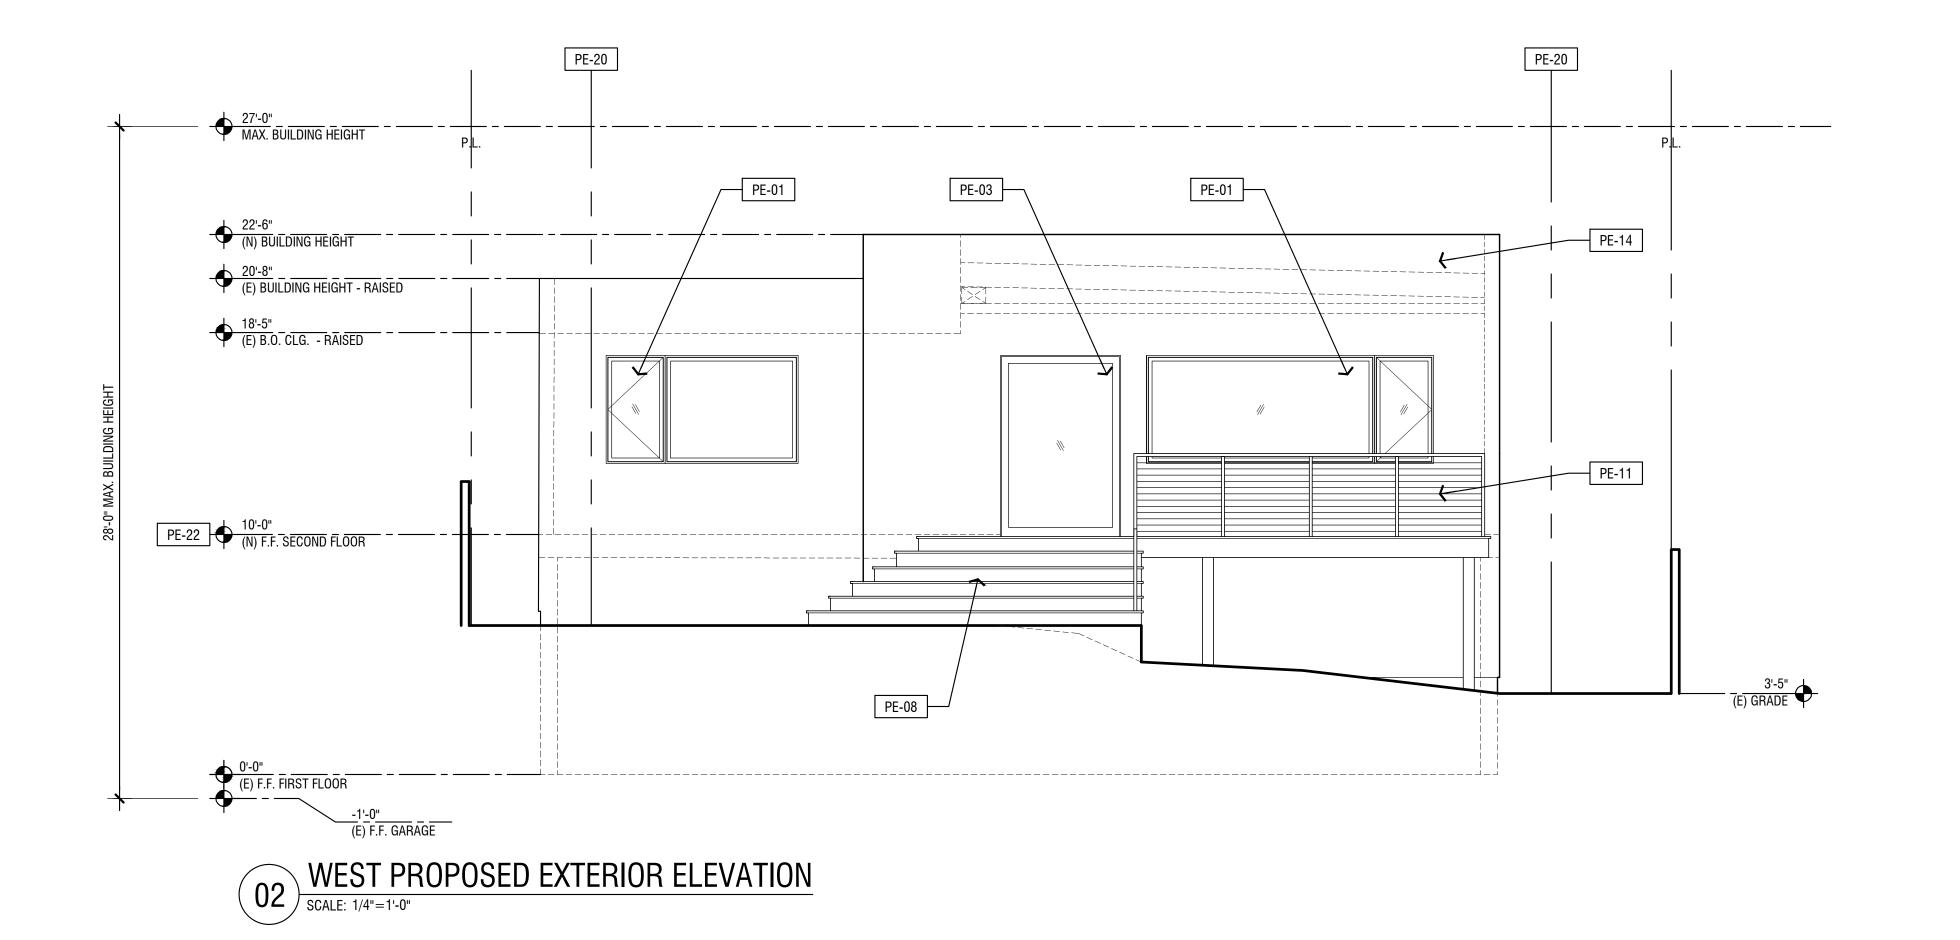

SHEET DATA 2022.11.28 22001 JOB NO.:

WASHINGTON- ERIC RESIDENCE 830 CERRITO STREE ALBANY, CALIFORNI, PARCEL # 66-2748-0

PLANNING DESIGN REVIEW

1/4" = 1'-0" SHEET TITLE

PROPOSED **EXTERIOR ELEVATIONS**

EVANS DESIGN STUDIO www.evans-design-studio.com Principal: Amber Evans m.510-326-0548

PROJECT

PROPOSED EXT. ELEV./ SECTION KEY NOTES PE-01 (N) FIBERGLASS WINDOW, SEE SCHEDULE ON SHEET A5.0 (N) EXTERIOR FIBERGLASS DOOR, SEE SCHEDULE ON SHEET A5.0 (N) ALUM. CLAD WD. EXTERIOR POCKET DOOR, SEE SCHEDULE ON SHEET A5.0 PE-04 (N) PARAPET AT ROOF PE-05 (N) INTERNAL STAIR BETWEEN FLOORS SHOWN DASHED PE-06 (N) PTD. STL. COLUMN PE-07 (N) CONC. SLAB ON GRADE (N) RDWD. (STAINED, SEALED) DECK AND STAIRS W/ GUARD - CABLE RAILS BTWN POSTS (N) SLOPED BUILT UP ROOF , SLOPE GUTTER, GUTTER TO SLOPE TO THRU WALL SCUPPER/ OVERFLOW (N) 6' TALL RDWD. GATE AND FENCE AT SIDE YARD. (N) STAIRS AT DECK - (5) 11" TREADS, (6) EQ. RISERS (MAX. 7 %") W/ 1X REDWOOD, STAINED AND SEALED (N) 1x4 STAINED AND SEALED CEDAR T&G SIDING UNDER CANOPY PE-13 (N) RETAINING WALL AT FIRST FLOOR TO REPLACE (E) IN (E) LOCATION PE-14 (N) STUCCO FINISH TO MATCH EXISTING PE-15 (N) PTD. GARAGE DOOR (N) LOWERED PARAPET OVER ON T.O. (E) WALL AT THE GARAGE ROOF. PE-17 SETBACK LINE, SEE SITE PLAN FOR MORE INFORMATION PE-18 (N) CANOPY AT FRONT DOOR, SLOPE BUILT UP ROOF AT CANOPY TO GUTTER BEHIND FASCIA. (N) WD. RAILROAD TIES AT SIDE YARD FOR STEPS/ SHORT RETAINING, GRADE TO LEVEL OUT BTWN TIES. PE-20 SETBACK, SEE SITE PLAN PE-21 (N) THRU WALL SCUPPER, OVERFLOW AND DOWNSPOUT, SEE SITE PLAN PE-22 (E) 2ND FLR. RAISED TO (N) HEIGHT INDICATED (TOTAL RAISED IS 2'-9") PE-23 (N) CONC. RETAINING WALL AT SIDE YARD, SEE EXTERIOR ELEVATIONS PE-24 INTERIOR LAYOUT NOT SHOWN

PROPOSED EXT. ELEV./ SECTION LEGEND

PE-XX PROPOSED ELEVATION KEY NOTE

SHEET DATA ATE: 2022.11.28

JOB NO.: 22001

PHASE: PLANNING


ISSUED: DESIGN REVIEW

SCALE: 1/4" = 1'-0"

SHEET TITLE

PROPOSED BLDG.

SECTION & STREET ELEV.

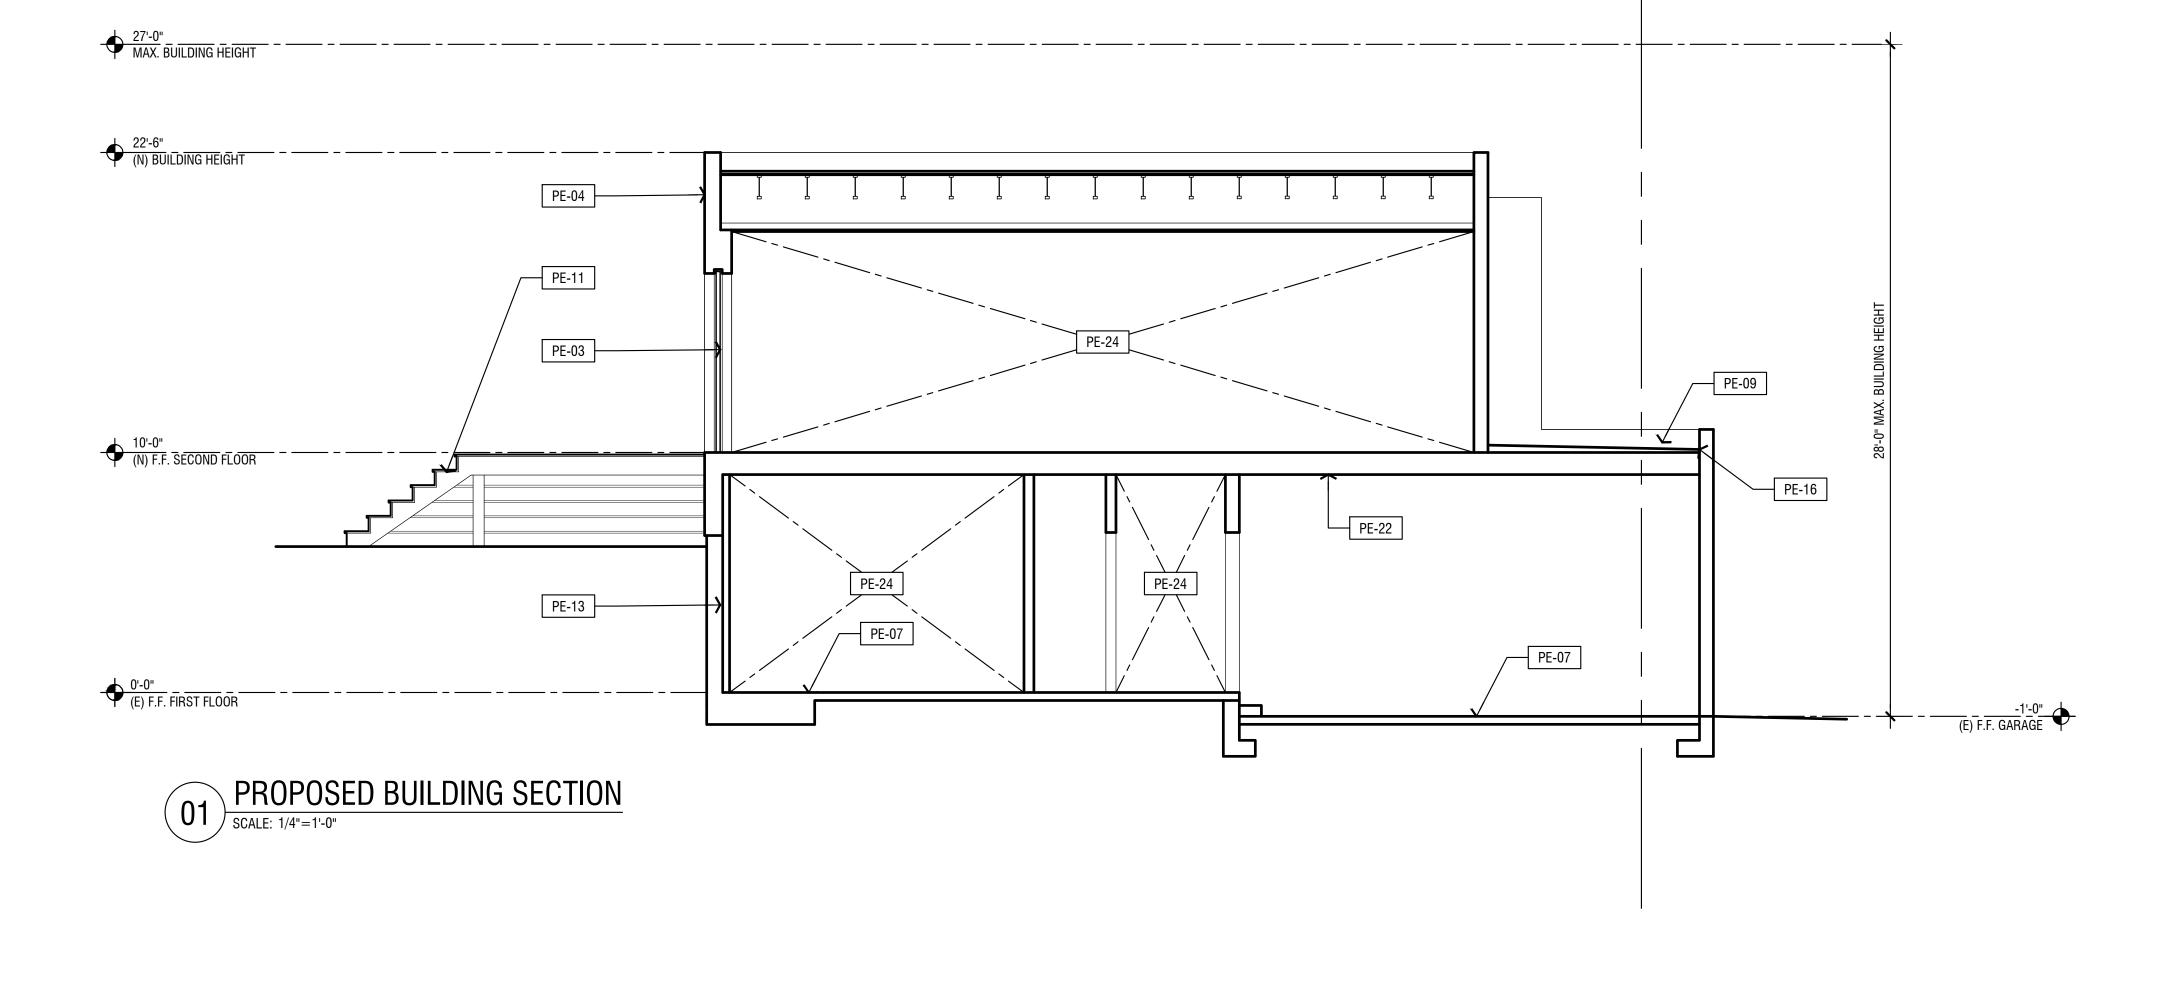

PE-20



PANORAMIC STREET PHOTO ELEVATION

SCALE: N.T.S.

DESIGNER

| EVANS DESIGN ST | UDIC |
|---------------------|-------|
| .evans-design-studi | o.con |
| Principal: Amber I | Evans |
| m.510-326 | -0548 |
| | |

| DOOR SCHEDULE | | | | | | | | | | | | |
|---------------|-------------------|----------|---------|----------------|-------|--------|----------------|--------|-------------------------------------|----------------------|-----------|-------|
| NO. | TYPE | LOCATION | | FIRE RATING | WIDTH | HEIGHT | MATERIAL | FINISH | GLAZING | MANUF./ MODEL NO. | HDW GROUP | NOTES |
| D01 | SEE EXT. ELEV. | EXTERIOR | ENTRY | | 3'-6" | 7'-6" | FIBERGLASS | TBD | INSULATED; LOW E2 SAFETY GLAZING | TBD | TBD | |
| D02 | SEE EXT. ELEV. | EXTERIOR | KITCHEN | | 5'-0" | 7'-6" | ALUM. CLAD WD. | TBD | INSULATED; LOW E2 SAFETY GLAZING | TBD | TBD | |
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| D00R | SCHE | DULE | | | | | | | | | | |
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| NO. | TYPE | LOCATION | | FIRE RATING | WIDTH | HEIGHT | MATERIAL | FINISH | GLAZING | MANUF./ MODEL NO. | HDW GROUP | NOTES |
| D01 | SEE EXT. ELEV. | EXTERIOR | ENTRY | | 3'-6" | 7'-6" | FIBERGLASS | TBD | INSULATED; LOW E2 SAFETY GLAZING | TBD | TBD | |
| D02 | SEE EXT. ELEV. | EXTERIOR | KITCHEN | | 5'-0" | 7'-6" | ALUM. CLAD WD. | TBD | INSULATED; LOW E2 SAFETY GLAZING | TBD | TBD | |
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PROJECT

WASHINGTON- ERICKSON RESIDENCE 830 CERRITO STREET ALBANY, CALIFORNIA PARCEL # 66-2748-0


SHEET DATA

DATE: 2022.11.28 JOB NO.: 22001

PHASE: PLANNING ISSUED:

SCALE: 1/4" = 1'-0" SHEET TITLE

SCHEDULES

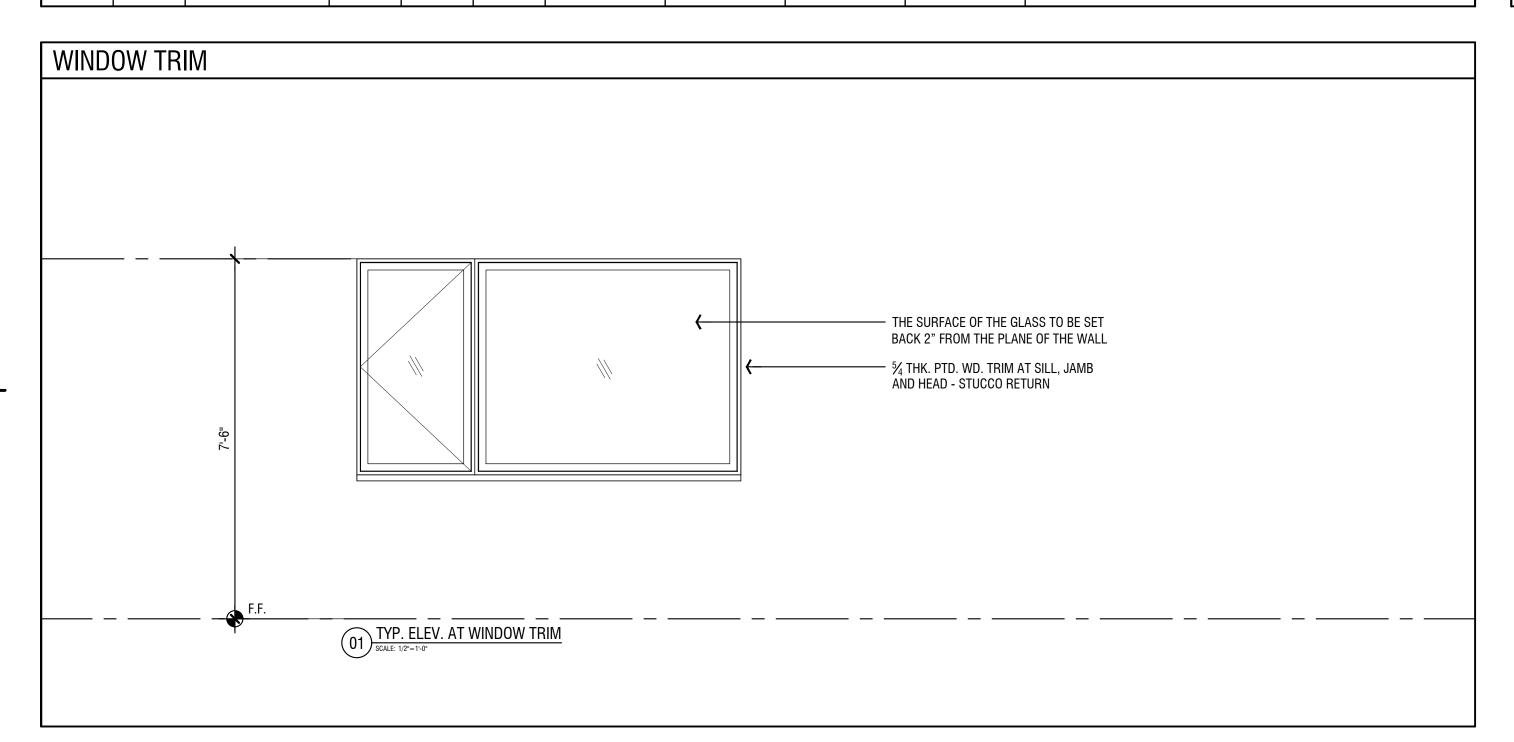

MANUF./

MODEL NO. MARVIN/

ESSENTIAL

ESSENTIAL

ESSENTIAL

ESSENTIAL

ESSENTIAL

ESSENTIAL

ESSENTIAL

ESSENTIAL

MARVIN/

ESSENTIAL

VSS-S06

NOTES

ESCA2656

ESCA2046

ESCAP6046/ ESCA2646

ESAWN3616/ ESAWN3616/ ESAWN3616

ESAWN3616/ ESAWN3616/ ESAWN3616

ESCA2646/ FIXED PICTURE WINDOW

SOLAR POWERED "FRESH AIR" SKYLIGHT

FIXED PICTURE WINDOW 9'-6" WIDE/ ESCA2646

FIXED PICTURE WINDOW 9'-6" WIDE/ ESCA2646

ESCA2646/ FIXED PICTURE WINDOW

GLAZING

INSULATED; LOW-E2

INSULATED; SAFETY

GLAZING

FINISH/ COLOR

EXT: TBD

EXT: TBD

INT: TBD;

EXT: TBD

INT: TBD;

EXT: TBD

INT: TBD;

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INT: TBD;

INT: TBD;

EXT: TBD

EXT: TBD

WINDOW SCHEDULE

EXT. ELEV.

EXT. ELEV.

SEE

EXT. ELEV.

EXT. ELEV.

SEE

EXT. ELEV.

SEE

EXT. ELEV.

EXT. ELEV.

W01

W03

W04

W05

W06

W07

W09

LOCATION

OFFICE

POWDER ROOM

MASTER BEDROOM

(E) BEDROOM NO.1

(E) BEDROOM NO.1

LIVING ROOM

LIVING ROOM

DINING ROOM

(E) BEDROOM NO.2

HEAD A.F.F.

7'-6"

7'-6"

WIDTH

2'-6"

2'-0"

8'-5"

10'-4 ½"

8'-0"

11'-11 ½"

10'-4 ½"

11'-11 ½"

8'-0"

3'-8"

HEIGHT

5'-6"

4'-6"

4'-6"

1'-6"

4'-6"

4'-6"

1'-6"

4'-6"

4'-6"

3'-10"

MATERIAL

FIBERGLASS

FIBERGLASS

A5.0

STREET CERRITO