CITY OF ALBANY CITY COUNCIL AGENDA STAFF REPORT

Agenda Date: June 6, 2022

Reviewed by: NA

SUBJECT: Annual Pavement Rehabilitation Program (CIP No. 21000)

Contract No. C21-10: Contract Amendment #3 for Marin Pavement Rehabilitation Project Phase 1 – Drainage Improvement Design

REPORT BY: Allison Carrillo, CIP Manager

Mark Hurley, Public Works Director/City Engineer

SUMMARY

The issue before Council is approval of a contract amendment to add drainage improvement design services to Contract No. C21-10 with CSG Consultants, Inc (CSG) to support the scope of the Marin Avenue Pavement Rehabilitation Project – Phase 1 limits.

STAFF RECOMMENDATION

That the Council adopt Resolution No. 2022-57, authorizing the City Manager to execute Contract Amendment #3 to Contract No. C21-10 to CSG Consultants, Inc in the amount of \$79,880 for drainage improvement design services using funds previously appropriated for the Annual Street Rehabilitation Program (CIP No. 21000).

BACKGROUND

The City of Albany currently maintains approximately 30 centerline miles of roads representing five million square feet of pavement. The Annual Street Rehabilitation Program is established to improve and maintain pavement conditions in the City. As part of this effort, in November 2020, Council approved the five-year Capital Improvement Plan (Resolution No. 2020-108), which included \$11 million of paving maintenance and rehabilitation over a five-year period.

On November 2, 2020, Council approved Contract No. C21-10 with CSG for pavement and curb rehabilitation design, including for Marin Avenue from Masonic Avenue to the Berkeley city limit. The design packages consist of approximately 21,376 feet of street rehabilitation across twelve streets. Locations included in the project were selected based on prioritizations in the 2019 Pavement Management Plan, in conjunction with other upcoming projects including EBMUD's (East Bay Municipal Utility District) planned pipeline replacement.

On January 19, 2021, Council approved Contract Amendment #1 to expand the limits of the Marin Avenue Pavement Rehabilitation project to add 3 additional blocks of Marin Avenue (Cornell Avenue to Masonic Avenue). Contract Amendment #2 added a bioretention basin on the north side of Marin Avenue between Masonic Avenue and Key Route Boulevard.

As part of the capital improvement delivery process, staff engage with utility companies on a regular basis to coordinate projects. In Winter 2022, EBMUD communicated to staff the intent to fully replace the existing waterline on Marin Avenue between Key Route Boulevard and Tulare Avenue ahead of the paving project due to the waterline's age, deteriorated condition, and shallow depth. This waterline was not previously identified during coordination with EBMUD ahead of the 2019 Pavement Management Plan. The waterline replacement project is under design with anticipated construction from September 2022 through February 2023.

Accommodating waterline replacement ahead of paving provides benefits to the pavement construction project by removing risk of delays and damages during construction and minimizes the risks of emergency work requiring excavation through the new pavement following project completion. To address EBMUD project coordination needs, staff have separated the project into two phases (Phase 1: Cornell to Key Route and Phase 2: Key Route to City Limits). Staff continue to work closely with EBMUD on project schedule with an intent to sequence construction of the Phase 2 paving limits shortly after completion of the EBMUD project.

DISCUSSION

The contract amendment under consideration expands the scope of work within Phase 1 to include drainage adjustments for ADA (American Disability Act) curb ramps and crosswalks construction. ADA standards require crosswalk running slope (e.g., the slope of the crosswalk in the direction of travel) to be no more than 5% for accessibility. Existing crosswalks on Marin Avenue have running slopes in excess of standards and achieving ADA compliance requires lowering of roadway elevations and/or raising of sidewalk elevations.

Preliminary intersection designs indicated a need for significant roadway elevation changes at intersections for ADA compliance (up to 22-inches of grade differential between depth of excavation and finish grade during construction) – resulting in significant impacts off-haul costs, constructability, and risks. Staff requested CSG to provide a cost-benefit-risk analysis with an aim to reduce costs and improve constructability. The analysis resulted in a finding that adding catch basins and lowering drainage pipes was anticipated to reduce overall project costs, improve design and constructability, and decrease disruptions and risks during construction. This approach provides an additional benefit in that final project costs would include investments into intersection drainage systems rather than increased material off-haul.

Staff requested and CSG provided a proposal for additional design services for drainage improvements for the Phase 1 limits of work in the amount \$79,880. Staff reviewed this estimate and find it to be competitive with other firms offering this service. Drainage improvements are anticipated under the Phase 2 limits of paving and will be brought to Council pending ongoing coordination with EBMUD planned waterline design.

SUSTAINABILITY CONSIDERATIONS

The proposed contract amendment supports the Council's Strategic Plan in the area of Transportation Safety and Implementation of the City's Active Transportation Plan. Additionally, this amendment includes installation of accessibility curb ramps that provide greater mobility by disabled persons, strollers, and persons in general. This promotes non-motorized travel, thereby reducing air emissions.

FINANCIAL CONSIDERATIONS

The budget for the first three years of the City's Annual Street Rehabilitation Program (CIP No. 21000) was appropriated by Council as part of the City's Capital Improvement Plan as adopted on November 16, 2020 (Resolution No. 2020-108). This budget reflects the City's commitment to investing annually in maintaining and improving the City's public right-of-way.

The following table details the expenditures for professional services Contract No. C21-10, including the proposed amendment.

Expenditures	Budget
Base Design Contract No. C21-10	\$499,980
Amendment #1 (Extend Project Limits)	\$42,240
Amendment #2 (Add Bioretention Basin)	\$34,450
Amendment #3 (Proposed)	\$79,880
Total Project Expenditures	\$656,550

The following table details the approved budget and funding sources for the Annual Street Rehabilitation Program (CIP No. 21000), Fiscal Years 2019/20 through 2021/22:

Funding Sources	FY19/20-21/22
1101 – Meas B LSR	\$1,270,000
1104 – VRF	\$140,000
1201 – Meas BB LSR (ACTC)	\$1,940,000

2006 – Meas F Street & Storm	\$4,600,000
2009 – State SB1/RMRA	\$900,000
Appropriations:	\$8,850,000

As of May 27, 2022, the City has either spent or encumbered approximately \$3.96 million of the appropriated program budget for the noted fiscal years. The CSG contract amendment recommended for award in this staff report is within the remaining appropriated program budget and no adjustments are needed.

Attachments

- 1. Resolution No. 2022-57
- 2. Contract Amendment #3

RESOLUTION NO. 2022-57

A RESOLUTION OF THE ALBANY CITY COUNCIL AUTHORIZING THE CITY MANAGER TO EXECUTE CONTRACT AMENDMENT #3 TO PROFESSIONAL SERVICES CONTRACT NO. C21-10 WITH CSG CONSULTANTS FOR PAVEMENT AND CURB REHABILITATION DESIGN SERVICES UNDER THE ANNUAL STREET REHABILITATION PROGRAM (CIP NO. 21000)

WHEREAS, the City of Albany currently maintains approximately 30 centerline miles of roads representing five million square feet of pavement; and

WHEREAS, the Annual Street Rehabilitation Program (CIP No. 21000) was established as part of the City's Capital Improvement Program as a reflection of the City's commitment to investing annually in maintaining and improving pavement conditions in the City, with budget previously appropriated in November 2020 (Resolution No. 2020-108); and

WHEREAS, on November 2, 2020, Council approved Contract No. C21-10 with CSG Consulting, Inc. for pavement and curb rehabilitation design services, including Marin Avenue from Masonic Avenue to the Berkeley city limit, as part of the new two-year design cycle for projects under the Annual Street Rehabilitation Program; and

WHEREAS, on January 19, 2021, Council approved Contract Amendment #1 to Contract No. C21-10 to expand the limits of the Marin Avenue Pavement Rehabilitation Project to add 3 additional blocks of Marin Avenue (Cornell Avenue to Masonic Avenue); and

WHEREAS, planned waterline replacement work by EBMUD (East Bay Municipal Utility District) necessitated separating the Marin Avenue Pavement Rehabilitation Project into two phases; and

WHEREAS, adding drainage improvements to the Marin Avenue Pavement Rehabilitation Project – Phase 1 limits will provide improved ADA (American Disability Act) curb ramp and crosswalk designs; and

WHEREAS, staff requested and CSG Consultants provided a fee proposal to add drainage improvements to the Marin Avenue Pavement Rehabilitatio Project – Phase 1 limits in the amount of \$79,880, which staff reviewed and concluded to be fair and reasonable.

NOW, THEREFORE, BE IT RESOLVED, that Council authorizes the City Manager to execute Contract Amendment #3 to Contract No. C21-10 to CSG Consultants, Inc in the amount of \$79,880 for drainage improvement design services using funds previously appropriated for the Annual Street Rehabilitation Program (CIP No. 21000).

PRESTON JORDAN, MAYOR

CONTRACT #C21-10 AGREEMENT FOR CONSULTANT SERVICES BETWEEN THE CITY OF ALBANY AND CSG Consultants, Inc

FOR PROJECT: PAVEMENT AND CURB REHABILITATION DESIGN

AMENDMENT OF AGREEMENT No. 3

made and entered into on this	GREEMENT FOR CONSULTANT SERVICES is day of, by and among the City of Albany a d CSG Consultants, Inc, ("CONSULTANT").				
In consideration of the mutual covenants and conditions set forth herein Contract #21-10, the parties agree as follows:					
Per request by the CITY, Contract #C21-10 shall be modified as follows: add drainage improvement design and utility investigation for Marin Pavement Rehabilitation Project Phase 1 as described attached Scope of Work. This AMENDMENT OF AGREEMENT shall be made part of the original AGREEMENT, Contract #C21-10. Original Contract was for the period of November 5, 2020 to November 4, 2022 and is not changed.					
Compensation for the AMENDMENT OF AGREEMENT shall be in the amount not to exceed \$79,880.00, as set forth in the attached AMEDMENT TO AGREEMENT SCOPE OF WORK. (Increase Original Contract of \$542,220.00 to #656,550.00).					
All work shall continue to be in compliance with Contract #C21-10, and in accordance with the approved Scope of Work, including any agreed upon modifications or extensions to the Scope of Work.					
	, the parties hereto have caused this AMENDMENT 1-10 to be executed the day and year first above				
CITY OF ALBANY:	CONSULTANT:				
ByNicole Almaguer, City Manager	By My Cyrus Kianpour, President				
AttestCity Clerk					
Attachments: Scope of Work Letter dated 3	/25/2022				



3875 Hopyard Road #141 Pleasanton, CA 94588 phone 925.931.0370 fax 925.931.0388

www.csgengr.com

April 20, 2022

Mr. Mark Hurley Public Work Director City of Albany 1000 San Pablo Avenue Albany, CA 94706

RE: City of Albany – Pavement and Curb Rehabilitation Design Project
Fee Amendment No.4 – Marin Ave Phase 1 Drainage Improvement Design and Utility Potholing

Dear Mr. Hurley,

CSG Consultants, Inc. (CSG) is pleased to present the following proposal to provide our professional services for additional design works for the Pavement and Curb Rehabilitation Project (Project) in the City of Albany (City).

As discussed with the City, CSG will perform engineering design to improve the existing drainage system along Marin Avenue between Talbot Avenue and Key Route Boulevard. The drainage improvements generally include addition of inlets and pipes, relocation of existing storm drain manholes/boxes located at curb ramps, upsizing of existing storm drain pipes, and utility potholing to resolve potential conflicts with other utilities.

Task 1 – Drainage Improvement Design

CSG will perform preliminary design of proposed storm drain improvements for initial review by the City. Once utility pothole data is available, perform final storm drain design based on the depths of existing utilities. The results of the utility depth will be shown on the drainage plans. Based on the pothole data, updates the proposed drainage improvements at the intersections of Talbot Avenue, Evelyn Avenue, Masonic Avenue and Key Route Boulevard. The drainage improvement plan sheets and details will be incorporated into the Final PS&E submittal. No profile for existing and proposed storm drainage will be shown on plans.

Task 2 – Utility Potholing

Bess Test Lab (BESS) will perform utility potholing at up to twenty-one (21) locations within the proposed Marin Avenue Phase 1 project area to obtain the locations and depths of existing utilities if necessary. USA markings will be requested. Signed traffic control plan will be submitted to obtain no-fee encroachment permit. Traffic control will be provided. After potholing work is complete, dispose excavated soil, and restore surface with backfill to the original conditions where applicable. A pothole data report will be provided. CSG will prepare and update pothole exhibits to identify utility conflicts at the proposed storm drain pipe crossings, coordinate with BESS, and review pothole data report.



Our fee for performing the tasks described above will not exceed **\$79,880** as shown on the attached Fee Amendment No. 4. All the fee will be on a time and materials basis and the actual fee for completing the works may cost less than what are being proposed.

We look forward to working on this project for the City. Please feel free to contact us at (925) 931-0370 or email me at lawrencel@csgengr.com.

Sincerely,

Lawrence Lau, P.E. Principal Engineer

CITY OF ALBANY - PAVEMENT AND CURB REHABILITATION DESIGN PROJECT												
FEE AMENDMENT No. 4 ESTIMATE FOR POTHOLE AND DRAINAGE DESIGN BY CSG CONSULTANTS - APRIL 21, 2022												
Task Description	Principal Engineer	Senior Engineer	Associate Engineer	Assistant Engineer	CS	iG To	otals		BESS TestLab (Potholing)	,	Task Totals	
Category	\$200	\$180	\$160	\$140	Hours		Cost				Cost	
Fask 1 - Drainage Improvement Design												
Coordinate with City Staff for Preliminary Drainage Design	4	8			12	\$	2,240			\$	2,240	
Perform Storm Drain Design	8	16	24		48	\$	8,320			\$	8,320	
Prepare and Update Drainage Plan Sheets and Details	10	24	60		94	\$	15,920			\$	15,920	
Cost Estimate	2	4	8		14	\$	2,400			\$	2,400	
Specifications	2	4			6	\$	1,120			\$	1,120	
					0	\$	-			\$	-	
Subtotal - Task 1	26	56	92	0	174	\$	30,000	\$	-	\$	30,000	
					<u> </u>					_		
Task 2 - Utility Potholing												
Utility Potholing (Up to 21 Locations)	3	4	16		23	\$	3,880		\$46,000	_	49,880	
Subtotal - Task 2	0	0	0	0	0 0	\$	2.000	,	46.000	\$	40.000	
Subtotal - Task 2	0	U	U	U	U	Þ	3,880	\$	46,000	Þ	49,880	
Total All Tasks	26	56	92	0	174		\$33,880		\$46,000		\$79,880	
Total All Tasks	20	30	J <u>_</u>		1/7		733,000		Ç- 1 0,000		Ç13,880	
TOTAL						\$	33,880	Ś	46,000	\$	79,880	

Printed on 4/21/2022 Prepared by CSG

Hayward (Corporate) | Fresno | Los Angeles | T. (408) 988-0101 | F. (408) 988-0103 Utility Locating - Ground Penetrating Radar (GPR) - Electromagnetic Pipe Locators Structural Concrete Scanning - Potholing Vacuum Excavation - CCTV Pipe Inspection TESTLAB, INC. Mobile LiDAR Scanning - 3D Scanning - 3D Utility Mapping - www.besstestlab.com

Date: April 21, 2022 **Quote No.:** AD-042122-2-Revised

Customer: CSG Consultants, Inc.

Site:Marin Avenue & Talbot AvenueCity:AlbanyRef. No.:County:Alameda

Requestor:Lawrence LauPhone No.:650-436-9628Email:lawrencel@csgengr.comFee Rate:Prevailing Wage

Project Description:

Schedule & coordinate USA markings. Bess to perform 21 potholes per attached exhibit. Bess to provide their own traffic control, surface removal, backfill and surface restoration per city standards. Bess to provide pothole report in PDF Format upon completion of job. Bess to locate/GPR all utilities (Optional). Without providing a utility locator cost will be 43,614.00.


Code	Code Service Description			Unit Price	Sub-Total
1.00	Project Management	0.4	DAY	1,160.00	\$ 464.00
2.00	Project Coordination	0.4	DAY	1,000.00	\$ 400.00
3.00	2-Person Surface Removal	3	DAY	2,565.00	\$ 7,695.00
4.00	2-Person Utility Potholing w/ hydro vacuum truck	3	DAY	3,240.00	\$ 9,720.00
5.00	2- Person Surface Restoration/ Backfill	3	DAY	2,565.00	\$ 7,695.00
6.00	6.00 Special Backfill Material (Class II, Slurry, Etc)		EA	95.00	\$ 1,995.00
7.00	OO Special Surface Restoration Material (Hot Patch, T-Cut)		EA	110.00	\$ 1,870.00
8.00	8.00 2-Person Traffic Control w/arrow truck		DAY	2,070.00	\$ 8,280.00
9.00	9.00 Reports/Sketches		HR	95.00	\$ 285.00
10.00	10.00 Traffic Control Plans - Standard		EA	300.00	\$ 1,200.00
11.00	11.00 Disposal Fee		EA	1,000.00	\$ 3,000.00
12.00	12.00 Special Surface Restoration (Concrete Sidewalk)		EA	395.00	\$ 1,580.00
13.00	13.00 1-Person Utility Locate & Mark w/ GPR		HR	175.00	\$ 1,400.00
			TOTAL	\$	45.584.00

Rates and Reimbursable Expenses:

- Overtime applies after 8 hours of work and weekends.
- Hourly rates are portal to portal from our nearest office, unless specified otherwise.
- Hourly rates apply to day shift (typical BESS day shift hours are 7:00 AM to 3:30 PM).
- Surcharge of \$45 a foot for depths past 10' to compensate for extra time and materials.
- Mileage expenses, if applicable, shall not exceed the rate established by the IRS for the current year.
- Outside reproductions, shipping, services and consultants will be charged at cost plus 10%.
- Cost of normal field supplies are included in the hourly rates.

I, the undersigned, have read, reviewed and accept the attached proposal, including attachments, and authorize Bess Testlab, Inc. to proceed with the work described above as witnessed and attested by my signature below.

By: Cyrus Kianpour	Title: President
(Print or Type Name)	(Print or Type Title)
In him	5-31-2022
(Signature)	(Date)

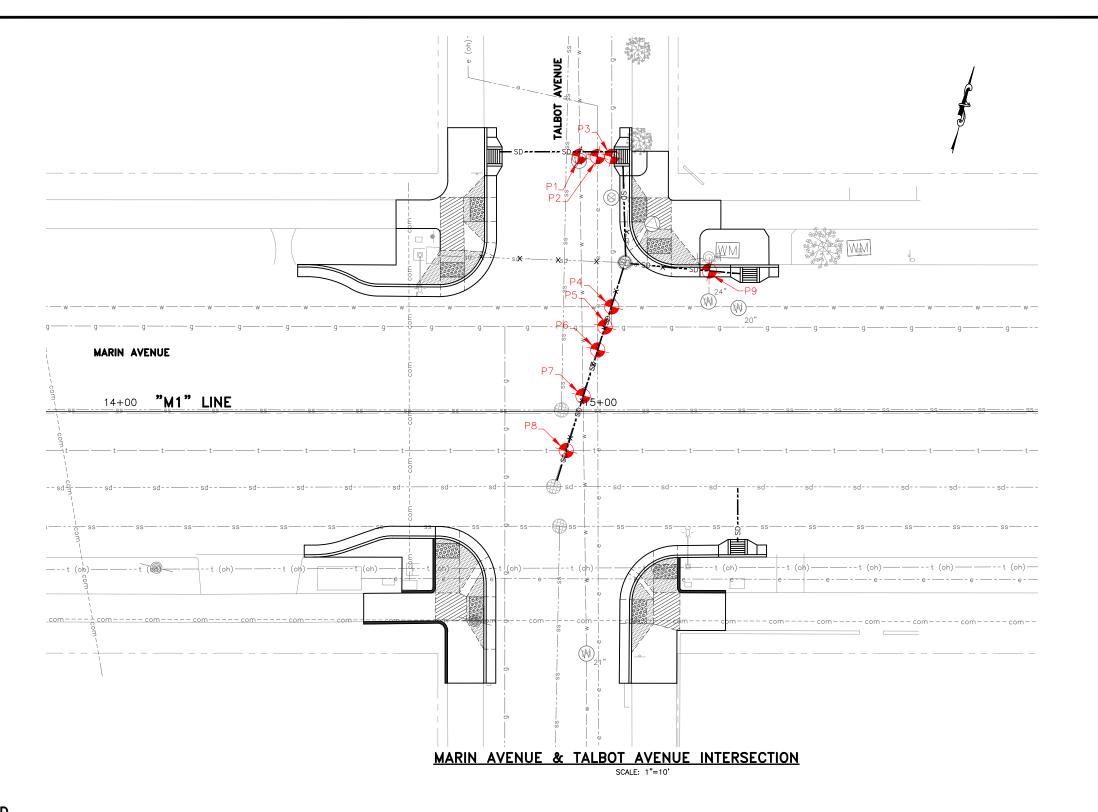

POTHOLE TABLE

POTHOLE No.	UTILITY TYPE				
P1	WATER				
P2	ELECTRIC				
P3	GAS				
P4	GAS & WATER				
P5	GAS				
P6	ELECTRIC				
P7	WATER				
P8	TELEPHONE				
P9	WATER				

LEGEND

PVC STORM DRAIN PIPE

EXISTING INLET



PROPOSED MANHOLE TYPE "A" INLET



PROPOSED STORM DRAIN MANHOLE



PROPOSED POTHOLE LOCATION

VERIFY SCALES: BAR SHOWN IS ONE INCH ON ORIGINAL DRAWING. IF NOT ONE INCH ON THIS SHEET, ADJUST SCALES ACCORDINGLY.





Know what's below. Call before you dig.

City of Albany Maintenance Center


540 Cleveland Avenue Albany, CA 94706 (510) 524-9543



PAVEMENT AND CURB REHABILITATION PROJECT MARIN AVE PHASE 1 (FROM CORNELL AVE TO KEY ROUTE BLVD)
POTHOLE LOCATIONS
MARIN AVE & TALBOT AVE INTERSECTION

DS/HA Designed By: Checked By: 04/15/2022

Sheet Number:

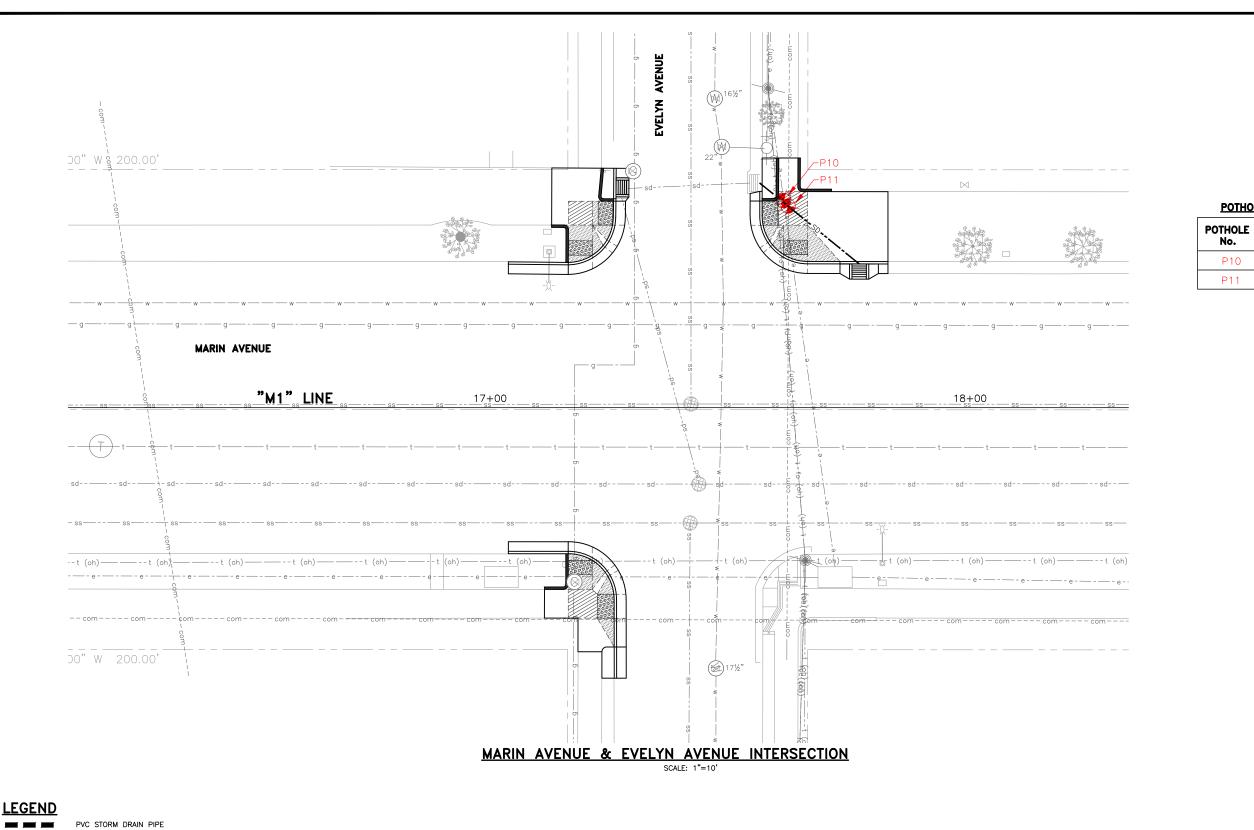



City of Albany Maintenance Center

540 Cleveland Avenue Albany, CA 94706 (510) 524-9543

POTHOLE TABLE

No. P10 UTILITY TYPE

ELECTRIC COMMUNICATION



Employee - Owned

PAVEMENT AND CURB REHABILITATION PROJECT MARIN AVE PHASE 1 (FROM CORNELL AVE TO KEY ROUTE BLVD)
POTHOLE LOCATIONS
MARIN AVE & EVELYN AVE INTERSECTION

Sub	Submittal / Revision:				
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Designed By: DS/HA Checked By: 04/15/2022

Sheet Number:

PROPOSED POTHOLE LOCATION


EXISTING INLET

PROPOSED MANHOLE TYPE "A" INLET

PROPOSED STORM DRAIN MANHOLE

VERIFY SCALES: BAR SHOWN IS ONE INCH ON ORIGINAL DRAWING

IF NOT ONE INCH ON THIS SHEET, ADJUST SCALES ACCORDINGLY.

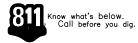

(D)

MARIN AVENUE & MASONIC AVENUE INTERSECTION SCALE: 1"=10'

POTHOLE TABLE

TOTHOLE TABLE								
POTHOLE No.	UTILITY TYPE							
P12	WATER							
P13	WATER							
P14	GAS							
P15	LATERAL WITHIN GI AREA							

LEGEND

PVC STORM DRAIN PIPE



PROPOSED MANHOLE TYPE "A" INLET

EXISTING INLET



PROPOSED STORM DRAIN MANHOLE



PROPOSED POTHOLE LOCATION

VERIFY SCALES: BAR SHOWN IS ONE INCH ON ORIGINAL DRAWING. IF NOT ONE INCH ON THIS SHEET, ADJUST SCALES ACCORDINGLY.



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CURB REHABILITATION PROJECT (FROM CORNELL AVE TO KEY ROUTE BLVD) POTHOLE LOCATIONS
AVE & MASONIC AVE INTERSECTION

PAVEMENT AND MARIN AVE PHASE 1

Submittal / Revision:

DS/HA Designed By: Checked By: Date: 04/15/2022

Sheet Number:

Know what's below. Call before you dig.

POTHOLE TABLE

TOTTOLL TABLE						
POTHOLE No.	UTILITY TYPE					
P16	LATERAL WITHIN GI AREA					
P17	WATER					
P18	GAS					
P19	GAS					
P20	WATER					
P21	WATER (EBMUD)					
	(

MARIN AVENUE & KEY ROUTE BLVD INTERSECTION
SCALE: 1"=10"

LEGEND

PVC STORM DRAIN PIPE





PROPOSED MANHOLE TYPE "A" INLET PROPOSED STORM DRAIN MANHOLE

EXISTING INLET



PROPOSED POTHOLE LOCATION

VERIFY SCALES: BAR SHOWN IS ONE INCH ON ORIGINAL DRAWING. IF NOT ONE INCH ON THIS SHEET, ADJUST SCALES ACCORDINGLY.



Know what's below. Call before you dig.

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PAVEMENT AND CURB REHABILITATION PROJECT MARIN AVE PHASE 1 (FROM CORNELL AVE TO KEY ROUTE BLVD)
POTHOLE LOCATIONS
MARIN AVE & KEY ROUTE BLVD INTERSECTION

Designed By: DS/HA Checked By: Date: 04/15/2022

Sheet Number: