
SHEET INDEX

- C1.0 TITLE SHEET
- C2.0 GENERAL NOTES & LEGEND
- C3.0 EXISTING CONDITIONS & DEMOLTION PLAN
- C3.1 EXISTING CONDITIONS & DEMOLTION PLAN
- C4.0 PAVING & DIMENSIONING PLAN C4.1 PAVING & DIMENSIONING PLAN
- C5.0 GRADING PLAN
- C5.1 GRADING PLAN
- C6.0 UTILITY PLAN C7.0 EROSION CONTROL PLAN
- PD-01 PAVEMENT DELINEATION AND SIGNAGE PLAN MARIN AVE / CURTIS ST
- PD-02 PAVEMENT DELINEATION AND SIGNAGE PLAN CURTIS ST / SONOMA AVE
- PD-03 RECTANGULAR RAPID FLASHING BEACON DETAIL SHEET

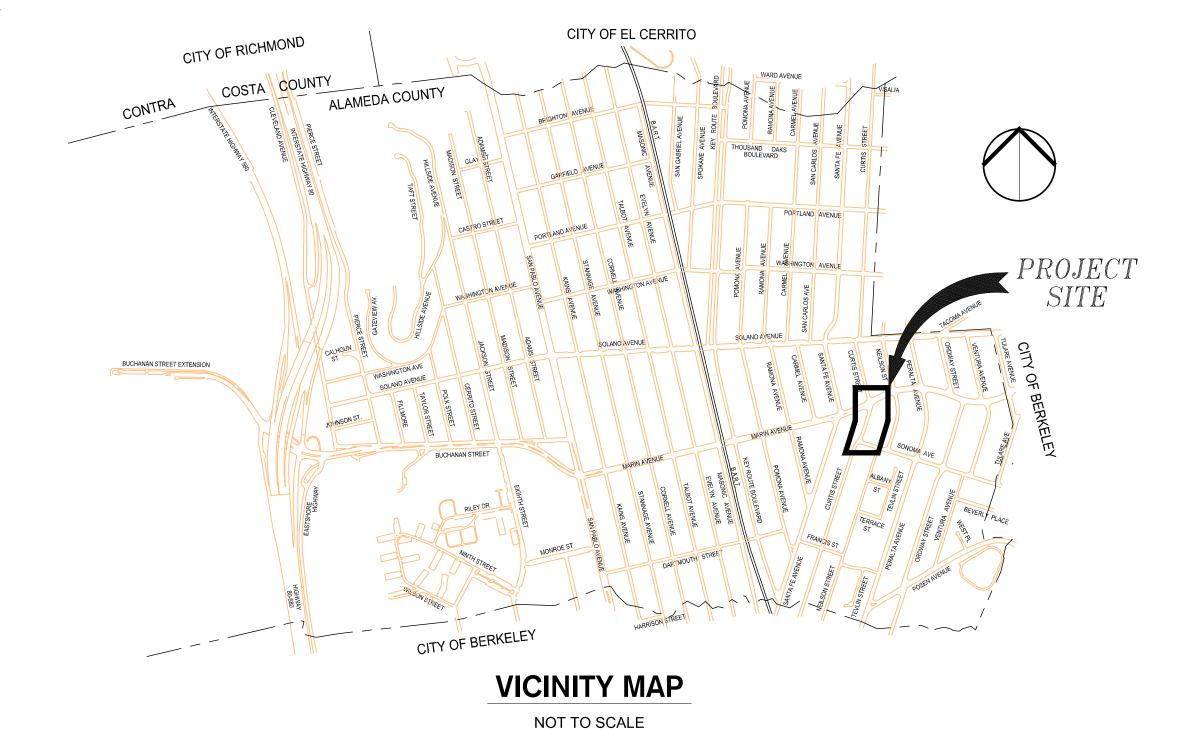

ALBANY, CA

ALAMEDA COUNTY, CALIFORNIA

PLANS

FOR THE CONSTRUCTION OF

PEDESTRIAN IMPROVEMENTS EAST SIDE OF MARIN ELEMEMNTARY SCHOOL

CITY OF ALBANY CONTRACT NO. C13-23 CALTRANS PROJECT NO. **CIP # P90 CITY COUNCIL**

Joanne Wile, Mayor

Peter Maass, Vice Mayor Marge Atkinson, Council Member Michael Barnes, Council Member Rochelle Nason, Council Member

Penelope Leach, City Manager Jeff Bond, Community Development Director Ray Chan, Public Works Director

APPLICABLE STANDARD PLANS

CALTRANS STANDARD PLANS (May 2010):

Pavement Markers and Traffic Lines - Typical Details Pavement Markers and Traffic Lines - Typical Details

Pavement Markings - Arrows

RSP A24C Pavement Markings - Symbols and Numerals Pavement Markings - Words and Crosswalks

Curb Ramp Details

T11 Traffic Control System for Lane Closure on Multilane Conventional Highways Traffic Control System for Lane Closure on Two Lane Conventional Highways T13

CITY OF ALBANY STANDARD PLANS WITH SPECIAL PROVISIONS:

Vertical Curb and Gutter

Residential Sidewalk/Driveway (Separated)

Sidewalk (Monolithic) Curb and Sidewalk Joints

Curb, Gutter, and Sidewalk Repairs

Residential Driveway Repairs

ST-7 Legends & Notes - Sidewalks, Driveways and Curb & Gutter ST-8 Street & Traffic Sign Mounting Standards

ST-8A Sign Anchor Detail

Sidewalk Drain ST-11 Type I Sign

CONTRA COSTA COUNTY (STORM DRAIN)

Inlet Frame and Grate

CD20i Type "A" Inlet

Signing & Striping Standards CD30i Manhole frame and cover

Type II Manhole Base

STANDARD PLANS FOR PUBLIC WORKS CONSTRUCTION - THE "GREENBOOK" Pipe Connection to Existing Storm Drains

BASIS OF BEARINGS

THE BEARING (N76°48'34"E) WAS HELD BETWEEN CITY OF ALBANY BRASS DISC MONUMENTS SET FLUSH IN THE NORTHEASTERLY RETURN OF RAMONA AVENUE AND MARIN AVENUE (LCC CP#10) AND AT THE NORTHERLY CONCRETE SIDEWALK LOCATED AT 1435/1437 MARIN AVENUE (LCC CP#11). THE DISTANCE MEASURED BETWEEN SAID MONUMENTS WAS 370.12 FEET.

HORIZONTAL DATUM

ALL COORDINATES AND DISTANCES SHOWN HEREON ARE BASED ON NORTH AMERICAN DATUM 1983, ZONE III, (CORS96) 2002.00 EPOCH, AND ARE GIVEN IN U.S. SURVEY FEET. DISTANCES SHOWN HEREON ARE AT GROUND LEVEL.

VERTICAL DATUM

ELEVATIONS SHOWN HEREON ARE BASED UPON CITY OF ALBANY MONUMENT (LCC CP#11, A 3" DIAMETER PUNCHED BRASS DISK LOCATED IN THE SIDEWALK ON THE NORTH SIDE OF MARIN AVENUE APPROXIMATELY 170 FEET WEST OF THE INTERSECTION OF MARIN AVENUE AND THE CENTERLINE OF EXISTING SANTA FE AVENUE (ELEV 85.91') LOCATED AT PROJECT "M" LINE STATION

ABBREVIATIONS

DROFESSIONA

RAY CHAN

56473


Exp. 06/30/15

CIVIL


FACE OF BUILDING

∖ Β	AGGREGATE BASE	FDAC	FULL DEPTH ASPHALT CONCRETE	RCP	REINFORCED CONCRETE PIPE
4C	ASPHALT CONCRETE	FOC	FACE OF CURB	RT	RIGHT
APPROX	APPROXIMATE	GALV	GALVANIZED	REQ'D	REQUIRED
3C	BEGIN CURVE	GB	GRADE BREAK	RET	RETURN
30C	BACK OF CURB	GRND	GROUND	S	SLOPE
BSW	BACK OF SIDEWALK	GTR	GUTTER	SD	STORM DRAIN
BVCE	BEGIN VERTICAL CURVE ELEVATION	GV	GAS VALVE	SDI	STORM DRAIN INLET
BVCS	BEGIN VERTICAL CURVE STATION	H, HORIZ	HORIZONTAL	SDMH	STORM DRAIN MANHOLE
	CURVE	HP	HIGH POINT	SF	SQUARE FEET
CCC	CONTRA COSTA COUNTY	HYD	HYDRANT	SHLD	SHOULDER
C&G	CURB AND GUTTER	IN	INCH	SSMH	SANITARY SEWER MANHOLE
CB	CATCH BASIN	INV	INVERT	SS	SANITARY SEWER
CD	CURB DRAIN	L	LENGTH	STA	STATION
CH	CURB HEIGHT	LED	LIGHT EMITTING DIODE	ST	STREET
CIP	CAST IRON PIPE	LG	LIP OF GUTTER	SW	SIDEWALK
CL	CENTERLINE	LS	LANDSCAPE	T	TOTAL
CMP	CORRUGATED METAL PIPE	LT	LEFT	TCE	TEMPORARY CONSTRUCTION EASEMENT
D, DIA	DIAMETER	MIN	MINIMUM	TEL	TELEPHONE
, DI	DRAINAGE INLET	Ν	NORTH, NORTHING, NEW	TOC	TOP OF CURB
OIP	DUCTILE IRON PIPE	NO	NUMBER	TS	TRAFFIC SIGNAL
OWG	DRAWING	NTS	NOT TO SCALE	TYP	TYPICAL
<u> </u>	EASTING, ELECTRICAL	Р	PAVEMENT	VAR	VARIES
ELEC	ELECTRICAL	(P)	PROPOSED	VC	VERTICAL CURVE
ΞC	END CURVE	PBB	PACIFIC BELL BOX	VCP	VITRIFIED CLAY PIPE
EDG	EDGE	PCC	PORTLAND CEMENT CONCRETE	W	WATER
EL OR ELEV	ELEVATION	PCC	POINT OF COMPOUND CURVE	W/	WITH
ELEC OH	ELECTRICAL OVERHEAD	PG	PROFILE GRADE	WM	WATER MAIN
EP, EOP	EDGE OF PAVEMENT	POC	POINT ON HORIZONTAL CURVE	2:1	2 HORIZONTAL TO 1 VERTICAL SLOPE
ETW	EDGE OF TRAVEL WAY	PRC	POINT OF REVERSE CURVE		
EVCE	END OF VERTICAL CURVE ELEVATION	PRKG	PARKING		
EVCS	END OF VERTICAL CURVE STATION	PVC	POLYVINYL CHLORIDE		

RAY CHAN DATE PUBLIC WORKS DIRECTOR

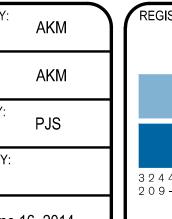



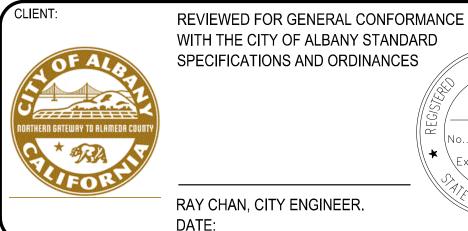

PEDESTRIAN IMPROVEMENTS **EAST SIDE OF MARIN ELEMENTARY SCHOOL**

RADIUS

RIGHT OF WAY

City of Albany Contract No. C13-23 Caltrans Project No. SRTS10-04-ALBANY-1

TITLE SHEET

DESIGN DOCUMENTS

100%

DRAWING: C1.0 OF

DRAWN BY: CHECKED BY: REVIEWED BY: June 16, 2014 DATE DESCRIPTION

EXIST, EX (E) EXISTING

- 2. ALL MATERIALS AND WORK TO CONSTRUCT THE IMPROVEMENTS SHOWN HERE ON THESE PLANS SHALL CONFORM TO THE LATEST EDITION OF COUNTY OF ALAMEDA PUBLIC WORKS AGENCY STANDARD SPECIFICATIONS AND DETAILS, AND THE LATEST EDITION OF THE STATE OF CALIFORNIA DEPARTMENT OF TRANSPORTATION STANDARD SPECIFICATIONS AND PLANS, UNLESS OTHERWISE NOTED.
- CONTRACTOR SHALL BE RESPONSIBLE FOR BEING FAMILIAR WITH THE PROJECT REQUIREMENTS CONTAINED IN THE STANDARD SPECIFICATIONS AND PROJECT SPECIAL PROVISIONS. CONTRACTOR SHALL MAINTAIN A COPY OF THE STANDARD SPECIFICATIONS AND APPROVED PROJECT PLANS AND SPECIAL PROVISIONS AT THE JOB SITE AT ALL TIMES.
- 4. CONTRACTOR SHALL OBTAIN ALL PERMITS NECESSARY FROM APPLICABLE AGENCIES TO PERFORM THE WORK SHOWN ON THESE PLANS PRIOR TO COMMENCING WORK.
- 5. WORKING HOURS SHALL BE FROM 8:00AM TO 5:00PM MONDAY THROUGH SATURDAY; AND 10:00AM TO 5:00PM SUNDAY AND HOLIDAYS. NO STARTUP OF HEAVY EQUIPMENT IS ALLOWED PRIOR TO 8:00AM. WRITTEN PERMISSION MUST BE OBTAINED FROM THE CITY ENGINEER PRIOR TO ANY WEEKEND OR HOLIDAY WORK. ALL WORK SHALL BE DONE BETWEEN JUNE 15, 2015 AND AUGUST 14, 2015 SO AS NOT TO CONFLICT WITH THE ALBANY UNIFIED SCHOOL DISTRICT SCHOOL YEAR UNLESS OTHERWISE DIRECTED BY THE CITY. CONTRACTOR SHALL CONFIRM LAST AND FIRST DAYS OF THE SCHOOL YEAR BY CONTACTING THE PERTAINING SCHOOL DISTRICT.
- 6. CONTRACTOR IS RESPONSIBLE FOR COORDINATING ALL WORK WITH THAT OF OTHERS, INCLUDING SUBCONTRACTORS, AT THE PROJECT SITE. CONTRACTOR SHALL HAVE A RESPONSIBLE PARTY WHO SHALL HAVE THE AUTHORITY TO REPRESENT AND ACT ON BEHALF OF THE CONTRACTOR AT THE PROJECT SITE DURING ALL WORKING HOURS.
- 7. CONTRACTOR SHALL NOTIFY THE CITY AT LEAST FORTY-EIGHT (48) HOURS PRIOR TO COMMENCEMENT OF WORK.
- 8. CONTRACTOR SHALL INFORM THE CITY ENGINEER AT LEAST THREE (3) WORKING DAYS IN ADVANCE WHEN WORK REQUIRING SPECIAL INSPECTION IS READY FOR INSPECTION. ALL WORK PERFORMED WITHOUT REQUIRED INSPECTION OR NOTIFICATION IS SUBJECT TO REMOVAL AND REPLACEMENT AT THE DIRECTION OF THE ENGINEER AT THE CONTRACTOR'S EXPENSE WITH NO IMPACT TO THE PROJECT SCHEDULE.
- 9. CONTRACTOR SHALL NOTIFY AND COORDINATE WITH ALL PUBLIC OR PRIVATE UTILITY COMPANIES AT LEAST FORTY-EIGHT (48) HOURS PRIOR TO COMMENCEMENT OF WORK ADJACENT TO EXISTING UTILITY FACILITIES.
- 10. CONTRACTOR SHALL COORDINATE ALL NECESSARY UTILITY RELOCATIONS, OR ANY WORK INVOLVING UTILITIES, WITH THE APPROPRIATE UTILITY COMPANIES.
- 11. CONTRACTOR SHALL NOTIFY UNDERGROUND SERVICE ALERT (USA) AT 811 AT LEAST TEN (10) DAYS PRIOR TO START OF CONSTRUCTION AND AT LEAST FORTY-EIGHT (48) HOURS PRIOR TO THE START OF ANY EXCAVATIONS.
- 12. EXISTING UNDERGROUND UTILITIES AND IMPROVEMENTS ARE SHOWN IN THEIR APPROXIMATE LOCATIONS BASED UPON RECORD INFORMATION AVAILABLE TO THE ENGINEER AT THE TIME OF PREPARATION OF THESE PLANS. LOCATIONS HAVE NOT BEEN VERIFIED IN THE FIELD AND NO GUARANTEE IS MADE AS TO THE ACCURACY OR COMPLETENESS OF THE INFORMATION SHOWN. CONTRACTOR SHALL VERIFY THE EXISTENCE AND LOCATIONS AND DEPTHS OF ANY UNDERGROUND UTILITIES OR STRUCTURES WITHIN THE LIMITS OF THE PROJECT. IT SHALL BE THE CONTRACTOR'S RESPONSIBILITY TO LOCATE, PROTECT AND MAINTAIN ALL EXISTING UTILITIES WITHIN THE LIMITS OF THE PROJECT. ANY ADDITIONAL COSTS INCURRED AS A RESULT OF CONTRACTOR'S FAILURE TO VERIFY LOCATIONS OF EXISTING UTILITIES PRIOR TO BEGINNING OF CONSTRUCTION SHALL BE BORNE BY THE CONTRACTOR.
- 13. CONTRACTOR SHALL PROVIDE 24 HOUR EMERGENCY TELEPHONE NUMBERS TO THE CITY POLICE DEPARTMENT, FIRE DEPARTMENT AND THE CITY ENGINEER AND NOTIFY THEM OF ANY LANE CLOSURES OR DETOURS. DETOURS SHALL NOT BE PERMITTED WITHOUT PRIOR WRITTEN APPROVAL BY THE CITY ENGINEER.
- 14. CONTRACTOR SHALL PROVIDE AND MAINTAIN SUFFICIENT SAFETY DEVICES INCLUDING BARRICADES, FENCING, WARNING SIGNS, LIGHTS OR FLAGGERS FOR THE SAFETY OF THE GENERAL PUBLIC WITHIN THE PROJECT AREA, AND TO THE SATISFACTION OF THE CITY ENGINEER. THIS REQUIREMENT SHALL APPLY CONTINUOUSLY AND NOT BE LIMITED TO NORMAL WORKING HOURS.
- 15. CONTRACTOR SHALL PROVIDE ONE (1) COMPLETE SET OF AS-BUILT DRAWINGS WITH CHANGES INDICATED IN RED INK ON FULL-SIZE DRAWINGS. AS-BUILTS SHALL BE DELIVERED TO THE CITY'S REPRESENTATIVE AT THE COMPLETION OF WORK PRIOR TO FINAL PROGRESS PAYMENT.

- 16. THE CONTRACTOR SHALL BE REQUIRED TO KEEP ALL CONSTRUCTION ACTIVITIES WITHIN THE PUBLIC RIGHT-OF-WAY AND EASEMENT OBTAINED FOR THE PROJECT UNLESS OTHERWISE SHOWN. THIS SHALL INCLUDE, BUT NOT BE LIMITED TO: VEHICLES AND EQUIPMENT, LIMITS OF TRENCH EXCAVATIONS, STOCKPILED NEW MATERIAL, EXCAVATED MATERIAL AND BACKFILL MATERIAL. IF THE CONTRACTOR REQUIRES ADDITIONAL CONSTRUCTION EASEMENTS, IT SHALL BE SOLELY THE CONTRACTOR'S RESPONSIBILITY TO OBTAIN SUCH EASEMENT FROM INDIVIDUAL PROPERTY OWNERS.
- 17. CONTRACTOR SHALL EXERCISE DUE CAUTION DURING CONSTRUCTION TO PROTECT AND MAINTAIN ANY EXISTING CONCRETE CURBS, GUTTERS, SIDEWALKS AND DRIVEWAYS IDENTIFIED TO REMAIN. ANY DAMAGE RESULTING FROM CONTRACTOR'S OPERATIONS SHALL BE REPAIRED AS DIRECTED BY THE ENGINEER AT NO ADDITIONAL COST TO THE CITY.
- 18. CONTRACTOR SHALL RESTORE ALL EXISTING PRIVATE AND PUBLIC IMPROVEMENTS TO THEIR EXISTING CONDITION OR BETTER TO THE SATISFACTION OF THE CITY ENGINEER INCLUDING, BUT NOT LIMITED TO: LANDSCAPING, IRRIGATION, DRIVEWAYS, AC PAVING, CONCRETE AND UTILITIES.
- 19. CONTRACTOR SHALL PROTECT ALL SURVEY MONUMENTS AND BENCHMARKS WITHIN THE WORK AREA AND SHALL NOT DESTROY ANY PERMANENT SURVEY MARKERS WITHOUT THE PRIOR CONSENT AND APPROVAL OF THE CITY ENGINEER. ANY PERMANENT SURVEY MONUMENTS OR MARKERS DESTROYED BY THE CONTRACTOR'S OPERATIONS SHALL BE REPLACED BY A LICENSED LAND SURVEYOR AT THE CONTRACTOR'S EXPENSE. CORNER RECORDS NEED TO BE FILED BEFORE REMOVAL AND AFTER RESETTING OF BRASS DISC MONUMENTS.
- 20. ALL TRAFFIC CONTROL REQUIRED FOR CONSTRUCTION ACTIVITIES SHALL CONFORM TO THE REQUIREMENTS OF THE LATEST EDITION OF THE CALIFORNIA MANUAL OF UNIFORM TRAFFIC CONTROL DEVICES (CA MUTCD). ALL PROPOSED LANE CLOSURES AND DETOURS SHALL BE SHOWN ON A TRAFFIC CONTROL PLAN TO BE SUBMITTED FOR REVIEW BY THE CITY ENGINEER AT LEAST FIVE (5) WORKING DAYS PRIOR TO THE SCHEDULED CLOSURE. NO LANE CLOSURE SHALL BE ALLOWED UNTIL THE TRAFFIC CONTROL PLAN IS APPROVED.
- 21. CONTRACTOR SHALL MAINTAIN ACCESS TO PRIVATE PROPERTY AND DRIVEWAYS, OR PROVIDE ALTERNATE/TEMPORARY ACCESS, AT ALL TIMES.
- 22. ALL TREES WITHIN THE PUBLIC RIGHT-OF-WAY SHALL BE PROTECTED FROM CONSTRUCTION DAMAGE, UNLESS OTHERWISE IDENTIFIED FOR REMOVAL ON PLANS (SEE TREE PROTECTION NOTES).
- 23. CONSTRUCTION ACTIVITIES AFFECTING SERVICE TO ANY FIRE HYDRANT SHALL BE COORDINATED WITH THE CITY FIRE DEPARTMENT A MINIMUM OF SEVENTY-TWO (72) HOURS PRIOR TO STARTING WORK.
- 24. CONTRACTOR SHALL CONFORM TO EXISTING STREETS, LANDSCAPE AND OTHER IMPROVEMENTS WITH A SMOOTH TRANSITION AND CONFORM IN PAVING, CURBS, GUTTERS AND SIDEWALKS TO AVOID ANY ABRUPT CHANGES IN GRADES OR CROSS SLOPES, LOW SPOTS, OR HAZARDOUS CONDITIONS.
- 25. CONTRACTOR SHALL VERIFY ALL FIELD DIMENSIONS AND ELEVATIONS SHOWN ON THE PLANS AND SHALL NOTIFY THE ENGINEER OF ANY DISCREPANCIES OR POTENTIAL CONFLICTS PRIOR TO PROCEEDING WITH THE WORK. ANY COSTS RESULTING FROM THE CONTRACTOR'S FAILURE TO REPORT SUCH CONFLICTS SHALL BE RESPONSIBILITY OF THE CONTRACTOR.
- 26. CONTRACTOR SHALL CONDUCT GRADING AND CONSTRUCTION ACTIVITIES IN SUCH A MANNER TO CONTROL AIRBORNE DUST AND RELATED DAMAGE TO ADJACENT PROPERTIES. SUFFICIENT WATERING TO CONTROL DUST AND WIND BLOWN MATERIAL IS REQUIRED AT ALL TIMES AND CONTRACTOR ASSUMES FULL LIABILITY FOR DAMAGE CLAIMS RELATING TO DUST.
- 27. ANY MATERIALS CONTAINING ASBESTOS OR OTHER HAZARDOUS MATERIALS THAT ARE REMOVED FROM THE PROJECT SITE MUST BE PERFORMED ONLY BY A PRE-APPROVED STATE OF CALIFORNIA LICENSED ASBESTOS ABATEMENT CONTRACTOR REGISTERED WITH CAL-OSHA. ASBESTOS AND OTHER HAZARDOUS MATERIAL HANDLING MUST BE IN ACCORDANCE WITH CAL-OSHA, FED-OSHA, U.S. EPA, CALIFORNIA DEPARTMENT OF TOXIC SUBSTANCE CONTROL AND THE BAY AREA AIR QUALITY MANAGEMENT DISTRICT REGULATIONS.
- 28. TJKM AND SIEGFRIED AND THEIR SUBCONSULTANTS WILL NOT BE RESPONSIBLE FOR OR LIABLE FOR ANY UNAUTHORIZED CHANGES TO OR USES OF THESE PLANS. ALL CHANGES TO THESE PLANS SHALL BE IN WRITING AND MUST BE APPROVED BY THE ENGINEER OF RECORD.
- 29. CONTRACTOR SHALL BE RESPONSIBLE FOR FULL COMPLIANCE WITH THE CITY'S STORM WATER PROGRAM AND THE ALAMEDA COUNTY NPDES PERMIT REQUIREMENTS AVAILABLE AT THE ALAMEDA COUNTYWIDE CLEAN WATER PROGRAM WEB SITE WWW.CLEANWATERPROGRAM.ORG.
- 30. THE PROJECT IS INTENDED TO BE CONSTRUCTED DURING DRY MONTHS. HOWEVER, A STORM WATER POLLUTION PREVENTION PLAN (SWPPP) SHALL BE SUBMITTED FOR APPROVAL. SUCH A SWPPP SHALL BE FULLY IMPLEMENTED.
- 31. ALL TEMPORARY TRAFFIC CONTROL DEVICES AND MEASURES SHALL CONFORM TO THE CALTRANS STANDARD PLANS 2010 AND CA MUTCD CURRENT EDITION. IF ANY DISCREPANCIES OCCUR, THE CALTRANS STANDARD PLANS SHALL GOVERN.
- 32. ALL TEMPORARY WATER POLLUTION CONTROL FEATURES AND MEASURES SHALL CONFORM TO THE CALTRANS STANDARD PLANS 2010 AND ALL NEW AND REVISED STANDARD PLANS AS POSTED ON THE CALTRANS WEBSITE.

TREE PROTECTION NOTES:

- 1. ARBORIST: IF TREE ROOTS ARE TO BE ENCOUNTERED, CONTRACTOR SHALL CONTACT THE CITY'S ARBORIST FOR "ON-CALL" CONSULTATION DURING CONSTRUCTION. NO EXCAVATION SHALL BE PERMITTED ON-SITE UNTIL THE ARBORIST HAS APPROVED THE PROPOSED STAGING AREA(S). NO TREE PRUNING, REMOVAL OF ROOT-CUTTING SHALL OCCUR WITHOUT THE ARBORISTS DIRECTION, RECOMMENDATIONS OR APPROVAL.
- 2. TRENCHING: ALL TRENCHING WITHIN THE DRIP LINE OF EXISTING TREES SHALL BE BY HAND WITH CARE TAKEN NOT TO DAMAGE ROOTS OVER 2" DIAMETER.
- 3. ADVANCE MARKING: CITY'S ARBORIST SHALL MARK LIMITS OF AREA WITHIN DRIP LINES IN ADVANCE PRIOR TO EXCAVATING.
- 4. PRUNING: TREES SHALL BE PRUNED ONLY AS RECOMMENDED BY CITY'S ARBORIST.
- 5. CONSTRUCTION OPERATIONS: NO CONSTRUCTION OPERATIONS SHALL BE CARRIED ON WITHIN THE DRIP LINE AREA OF ANY TREE DESIGNATED TO BE SAVED EXCEPT AS AUTHORIZED BY THE CITY ARBORIST.
- 6. STORAGE: THE AREA UNDER THE DRIP LINE OF THE TREE SHALL BE KEPT CLEAN. NO CONSTRUCTION MATERIALS NOR CHEMICAL SOLVENTS SHALL BE STORED OR DUMPED UNDER A TREE.


CONSTRUCTION STAKES:


CONTRACTOR IS RESPONSIBLE FOR HIRING A LICENSED LAND SURVEYOR OR A QUALIFIED REGISTERED CIVIL ENGINEER TO PROVIDE STAKING AND MONUMENT PRESERVATION FOR THE PROJECT.

GENERAL LEGEND

EXISTING	<u>NEW</u>	DESCRIPTION
-	-	UTILITY POLE
OR ()	OR OR	ELECTROLIER/LUMINAIRE
+•+		FIRE HYDRANT
-	1	ROADSIDE SIGN
⊕ or ₩ _{WV}	$oldsymbol{\Theta}$	WATER VALVE
\oplus OR \bowtie_{GV}		GAS VALVE
ss	SS	SANITARY SEWER LINE
w	W	WATER LINE
sd	SD	STORM DRAIN LINE
ts		TRAFFIC SIGNAL CONDUIT
—— е ——		UNDERGROUND ELECTRIC LINE
oh	——ОН——	OVERHEAD UTILITY LINE
g	—— G ——	GAS LINE
—X——X—	—X——X—	FENCE
		MONUMENT LINE
S OR S	S	SANITARY SEWER MANHOLE
D or d		STORM DRAIN MANHOLE
OR		STORM DRAIN INLET

4					
				DESIGNED BY:	AKM
				DRAWN BY:	AKM
				CHECKED BY:	PJS
				REVIEWED BY:	
	REV	DATE	DESCRIPTION	DATE: June 1	6, 2014

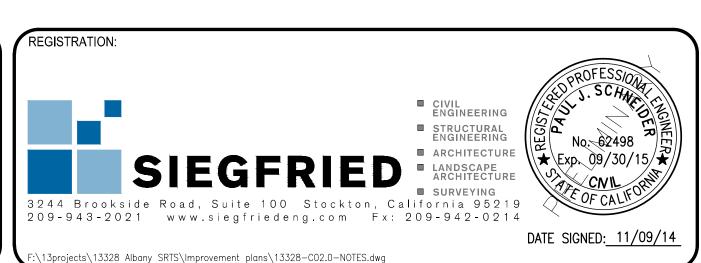

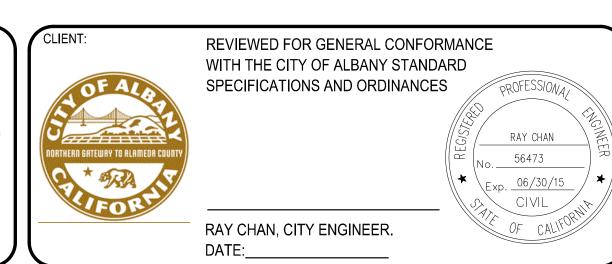

ALBANY, CA

PEDESTRIAN IMPROVEMENTS
EAST SIDE OF MARIN ELEMENTARY
SCHOOL

City of Albany Contract No. C13-23
Caltrans Project No. SRTS10-04-ALBANY-1


GENERAL NOTES & LEGEND

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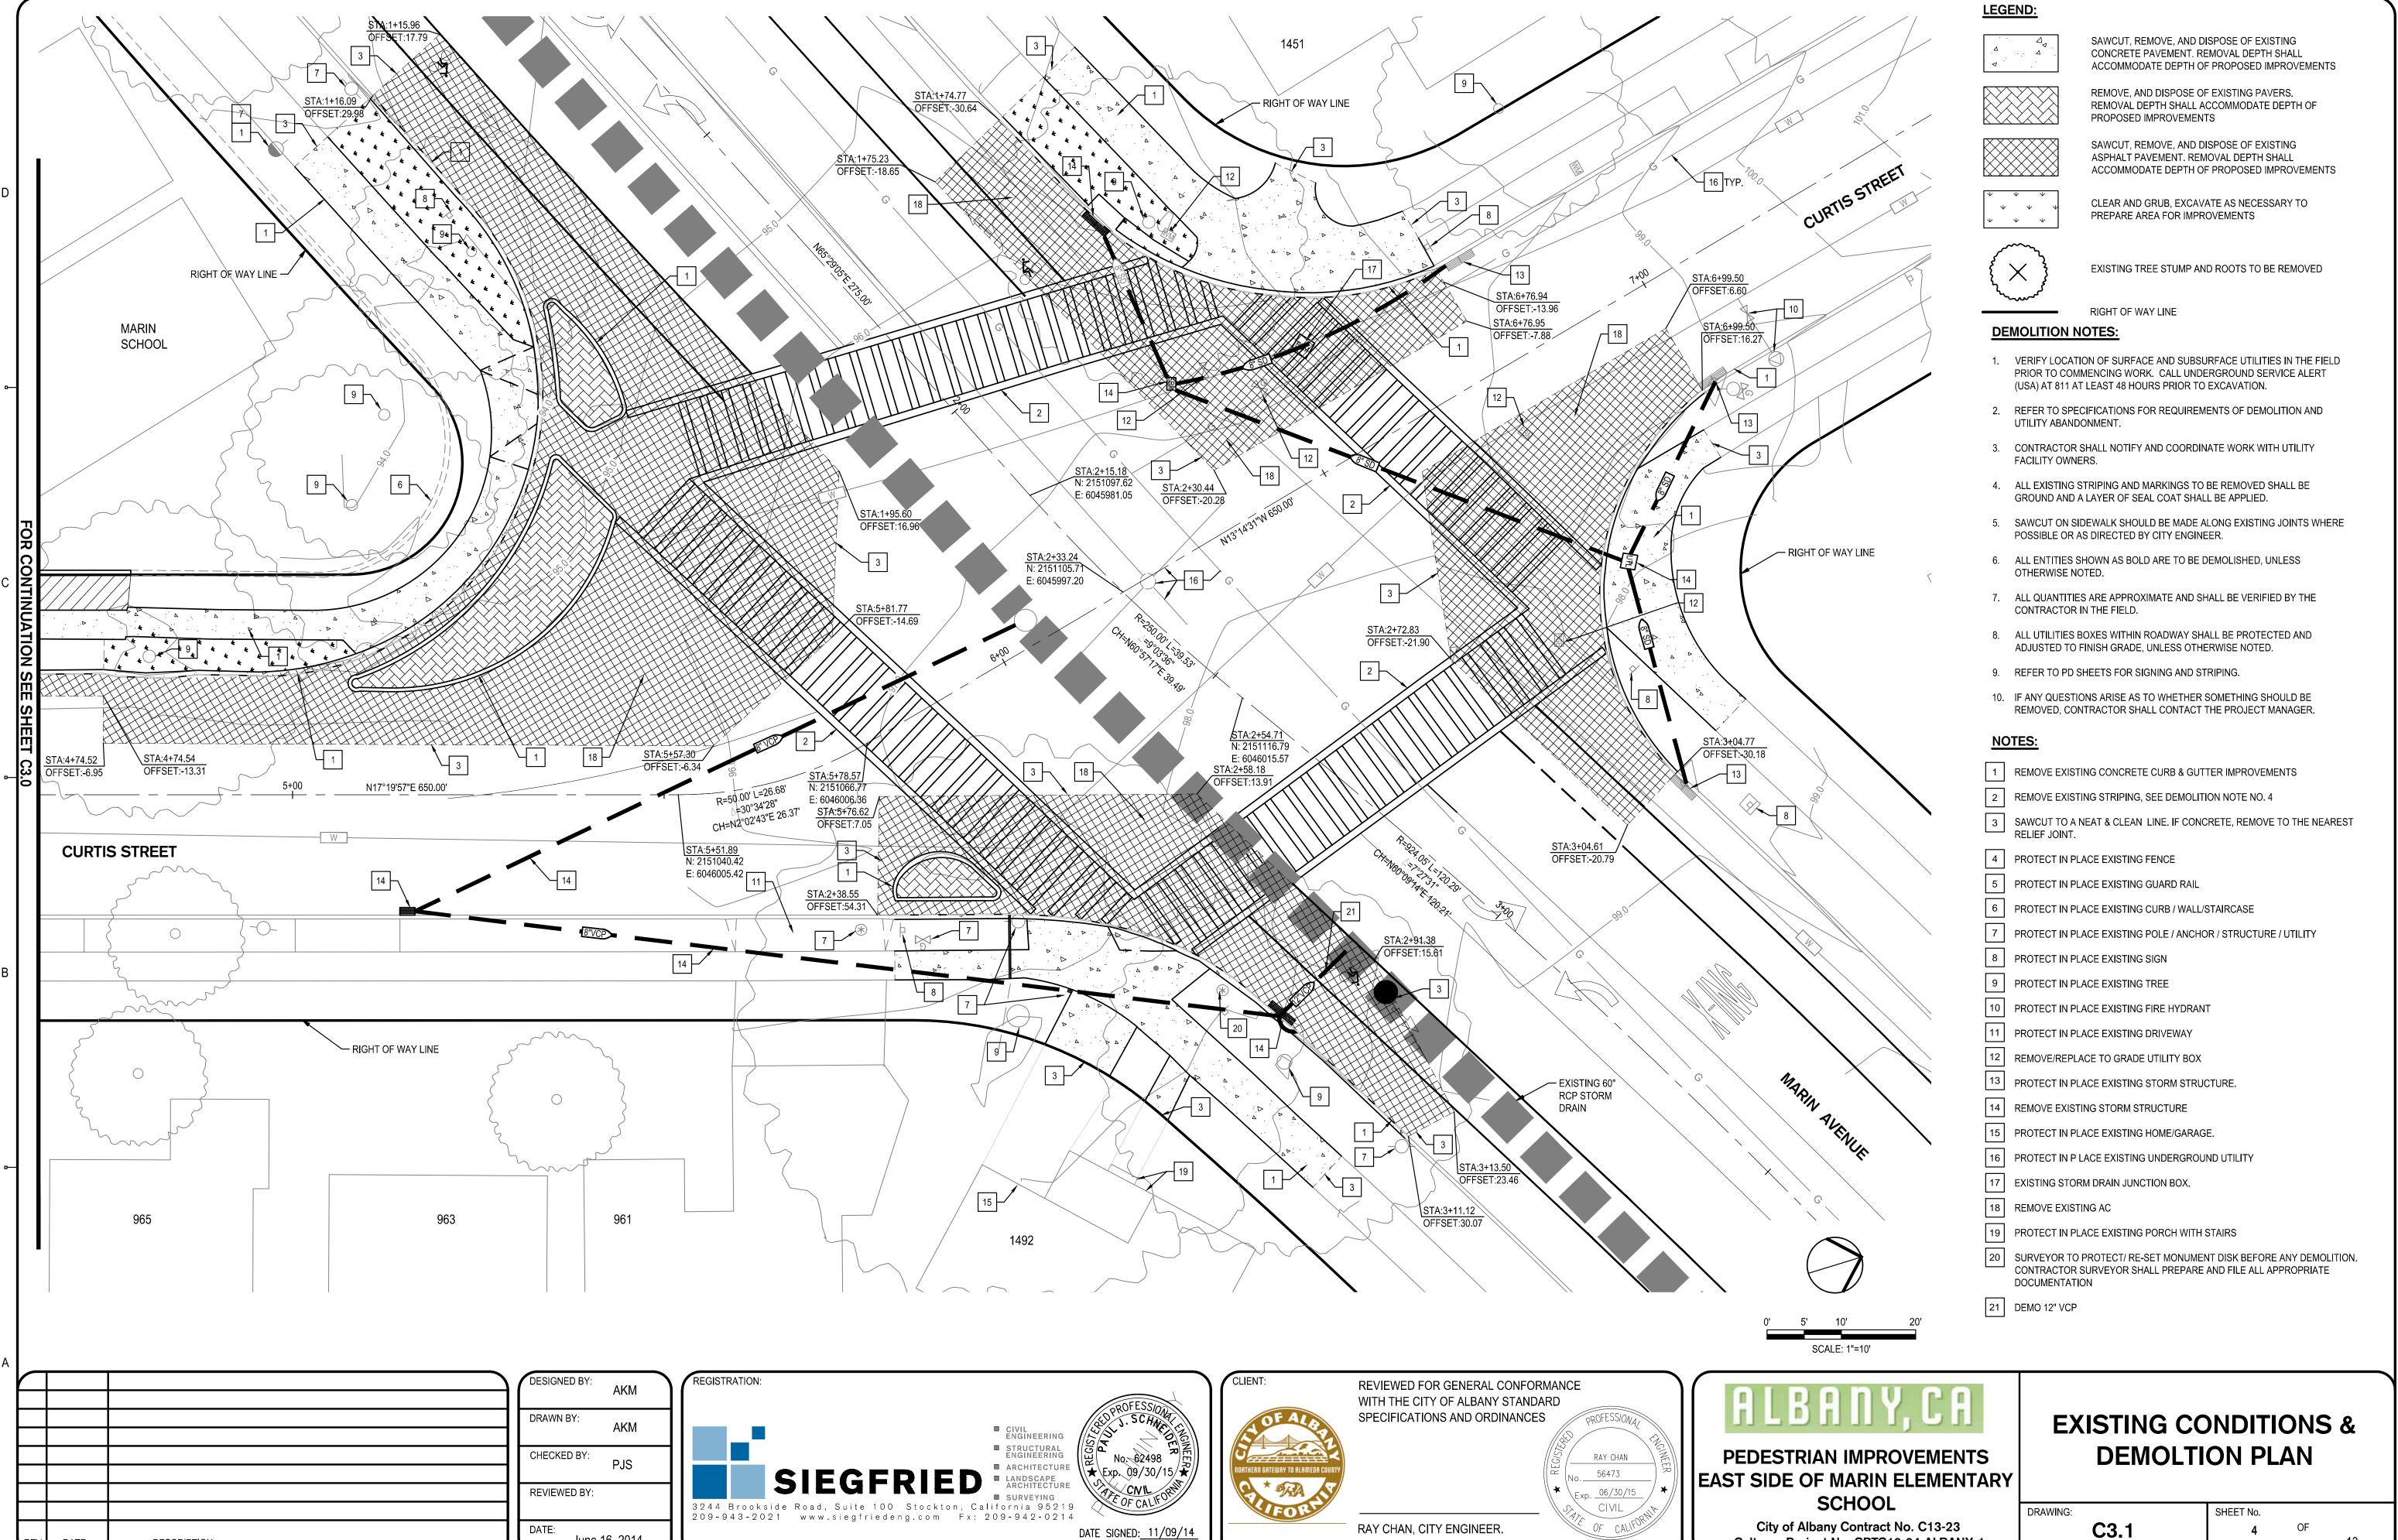
C2.0

SHEET No.
2

OF

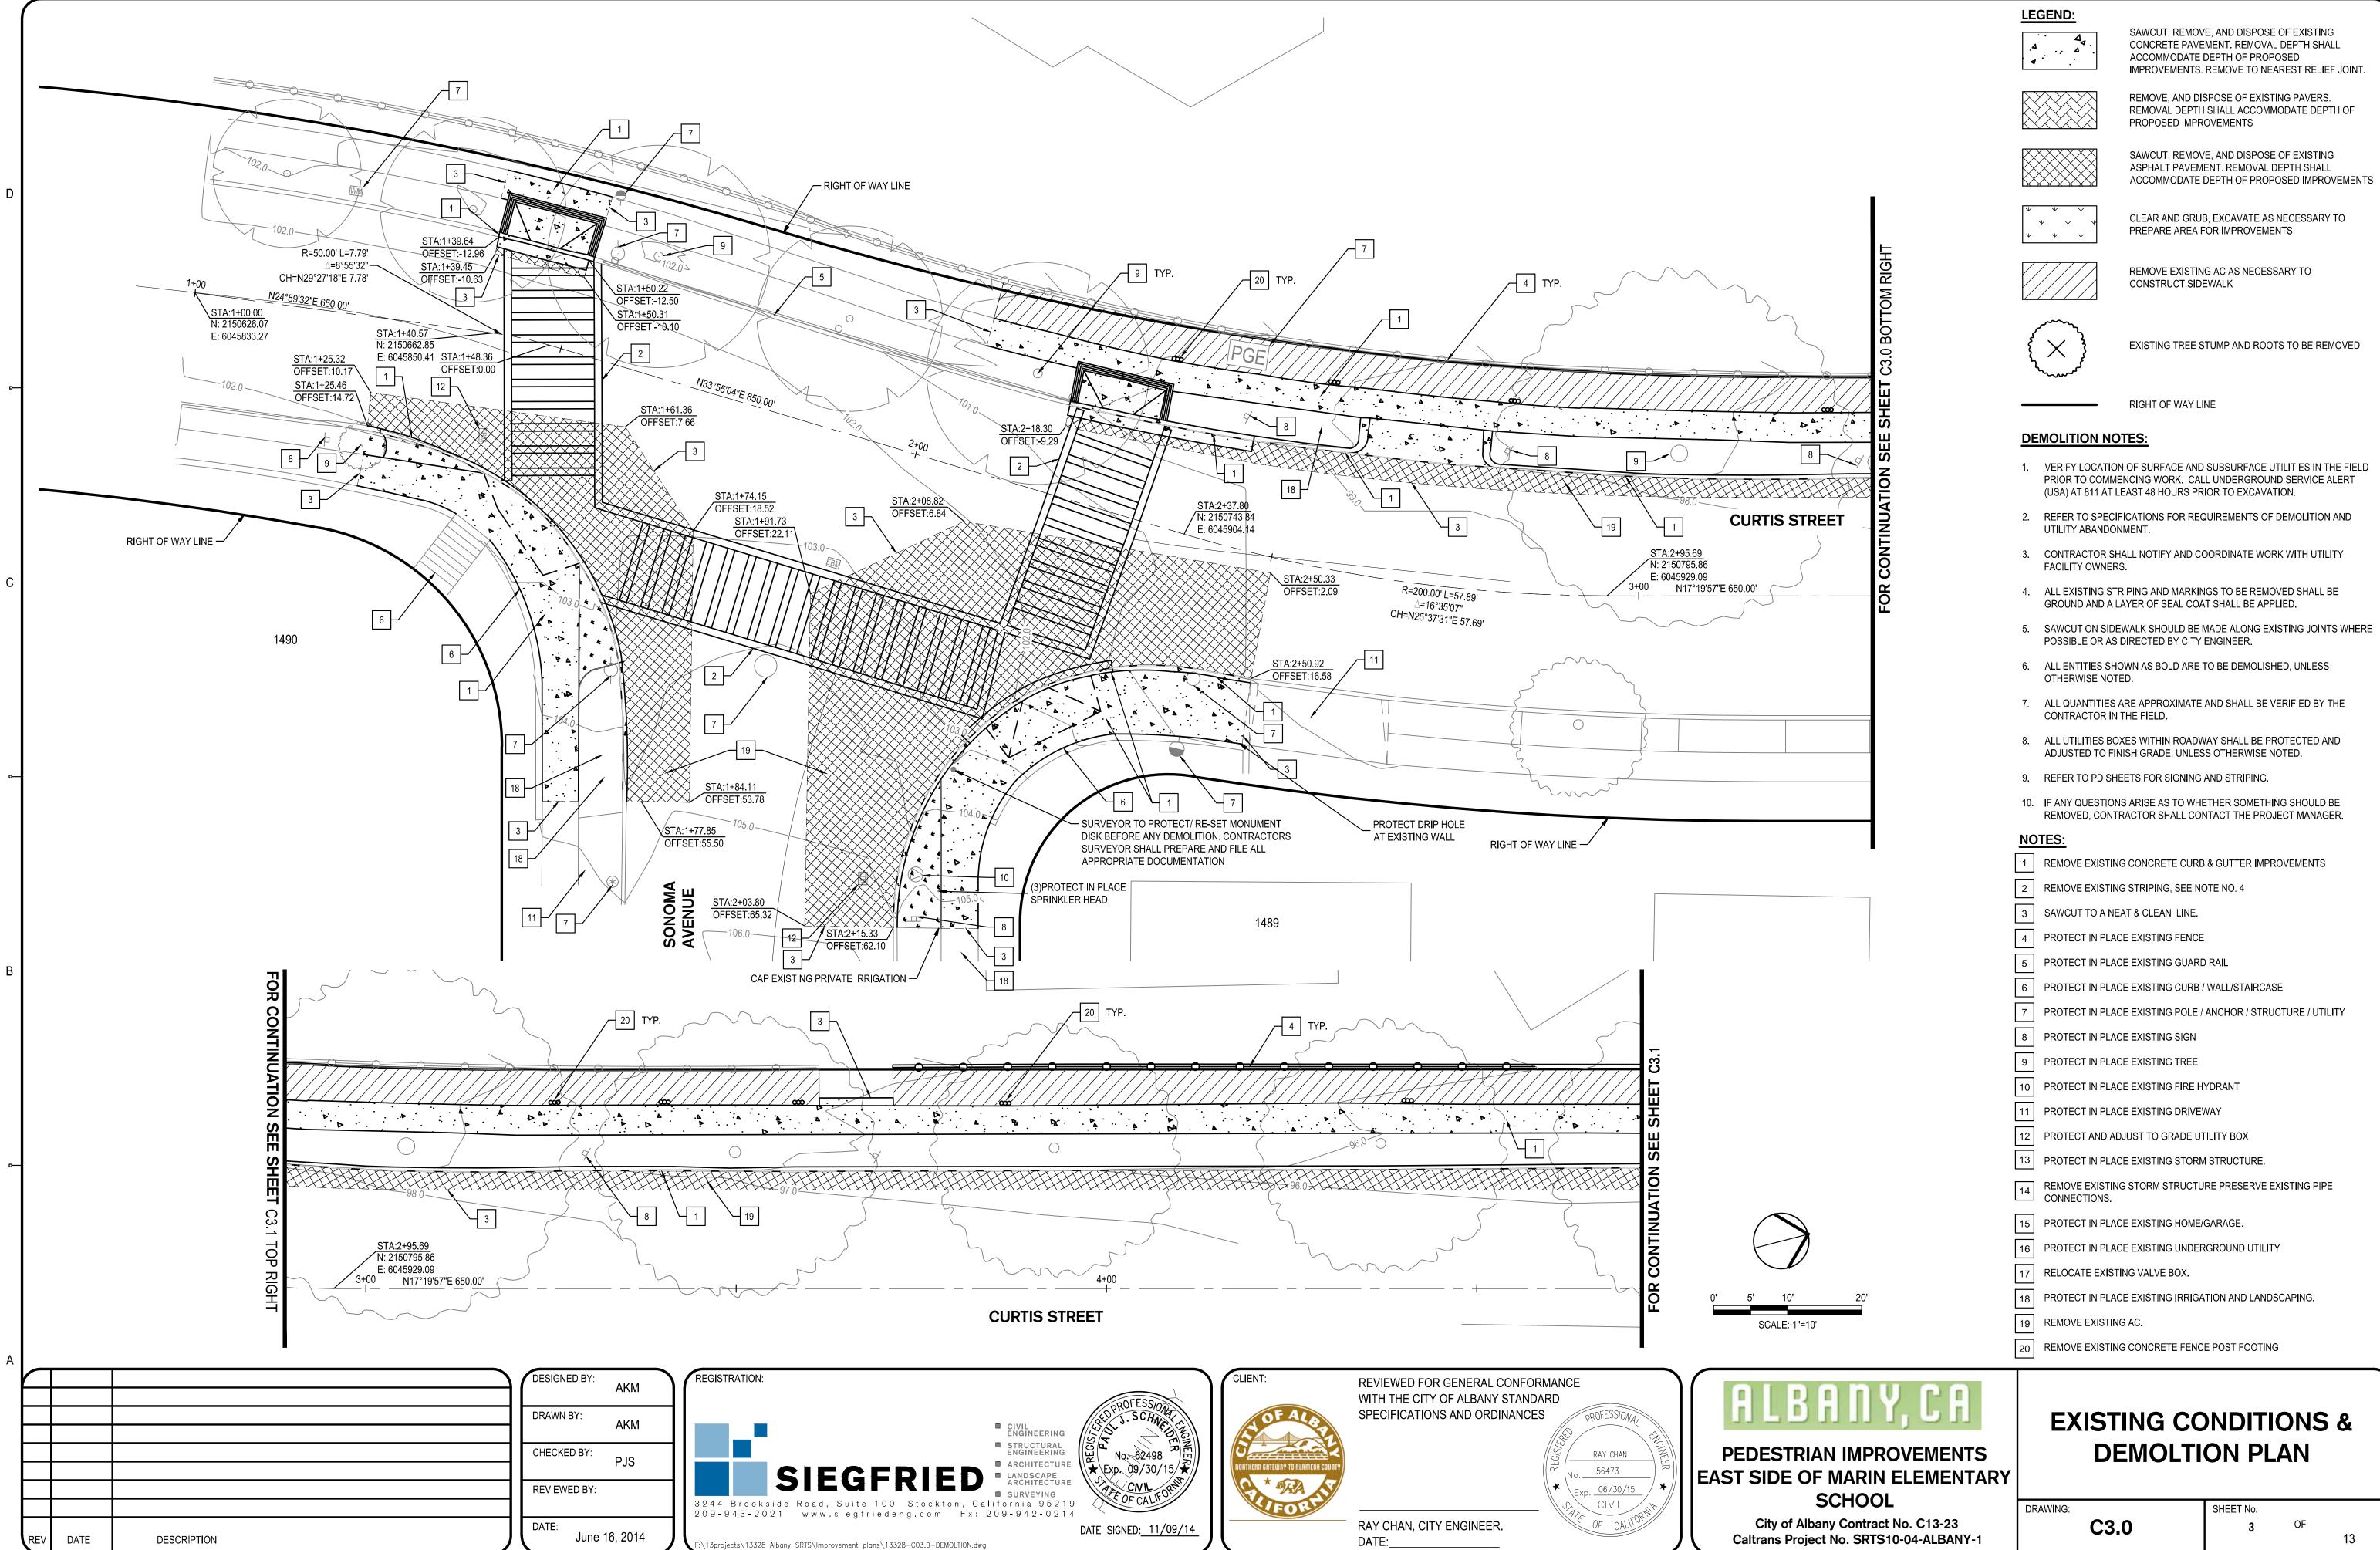

DESIGN DOCUMENTS



June 16, 2014

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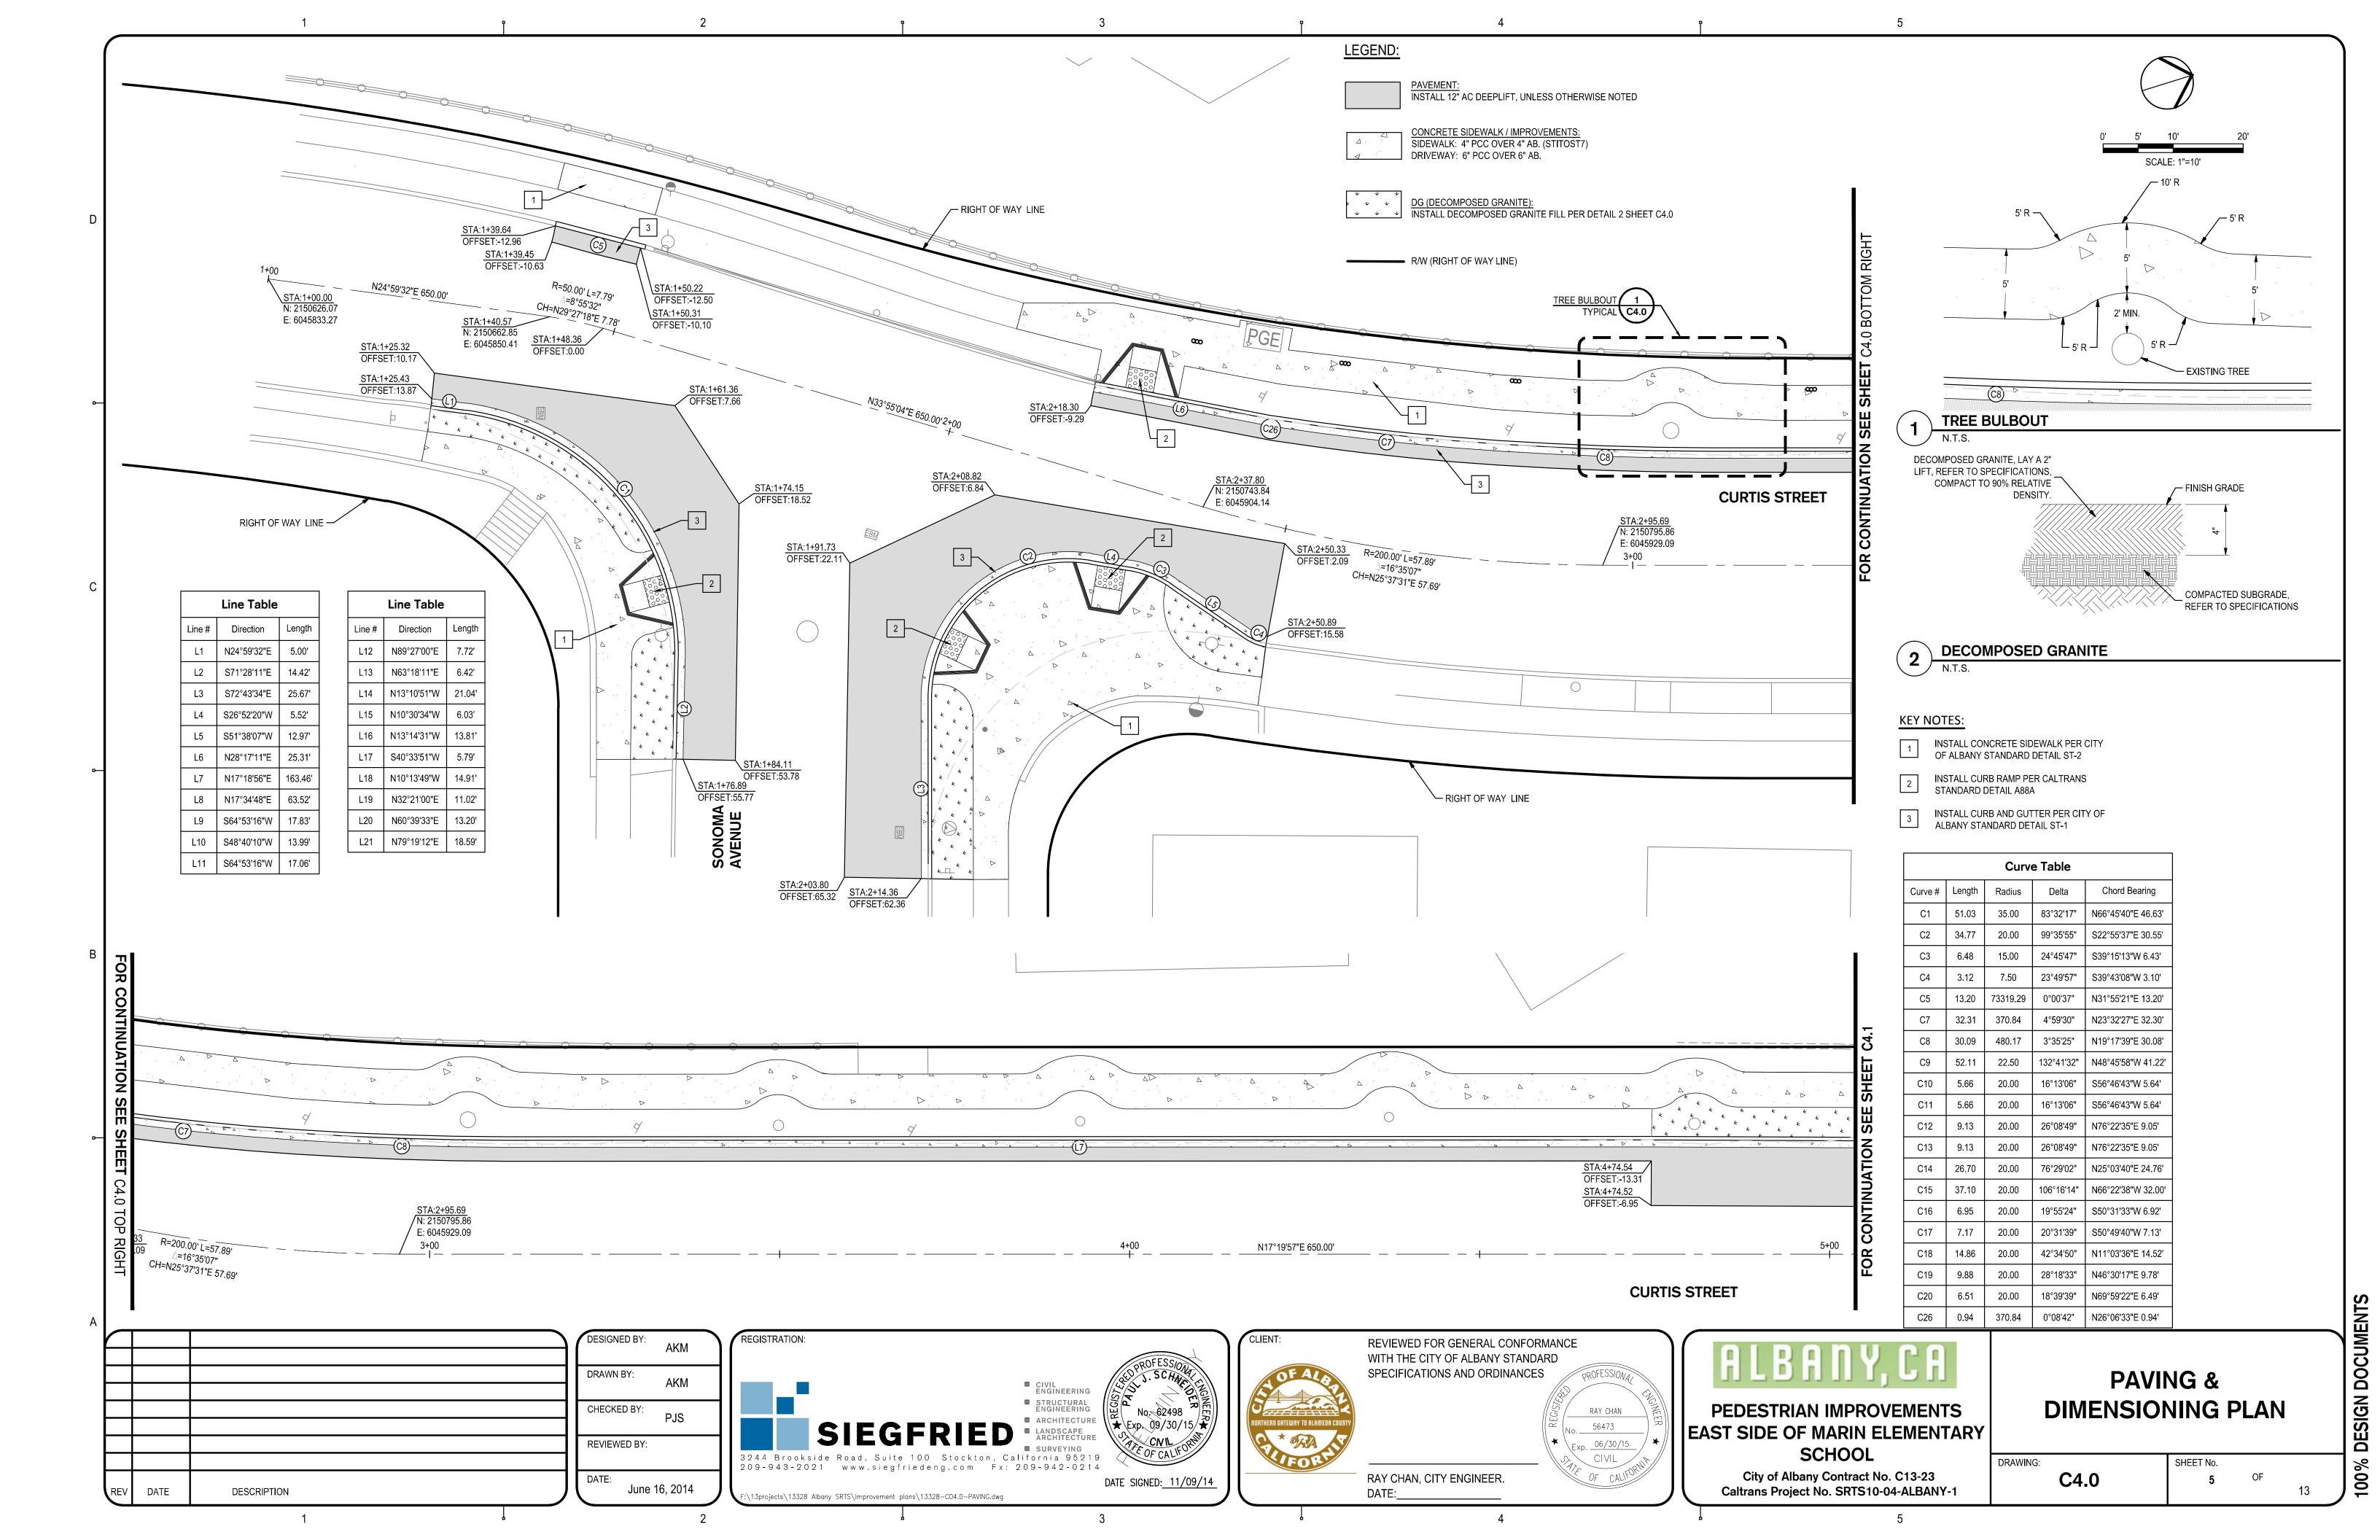
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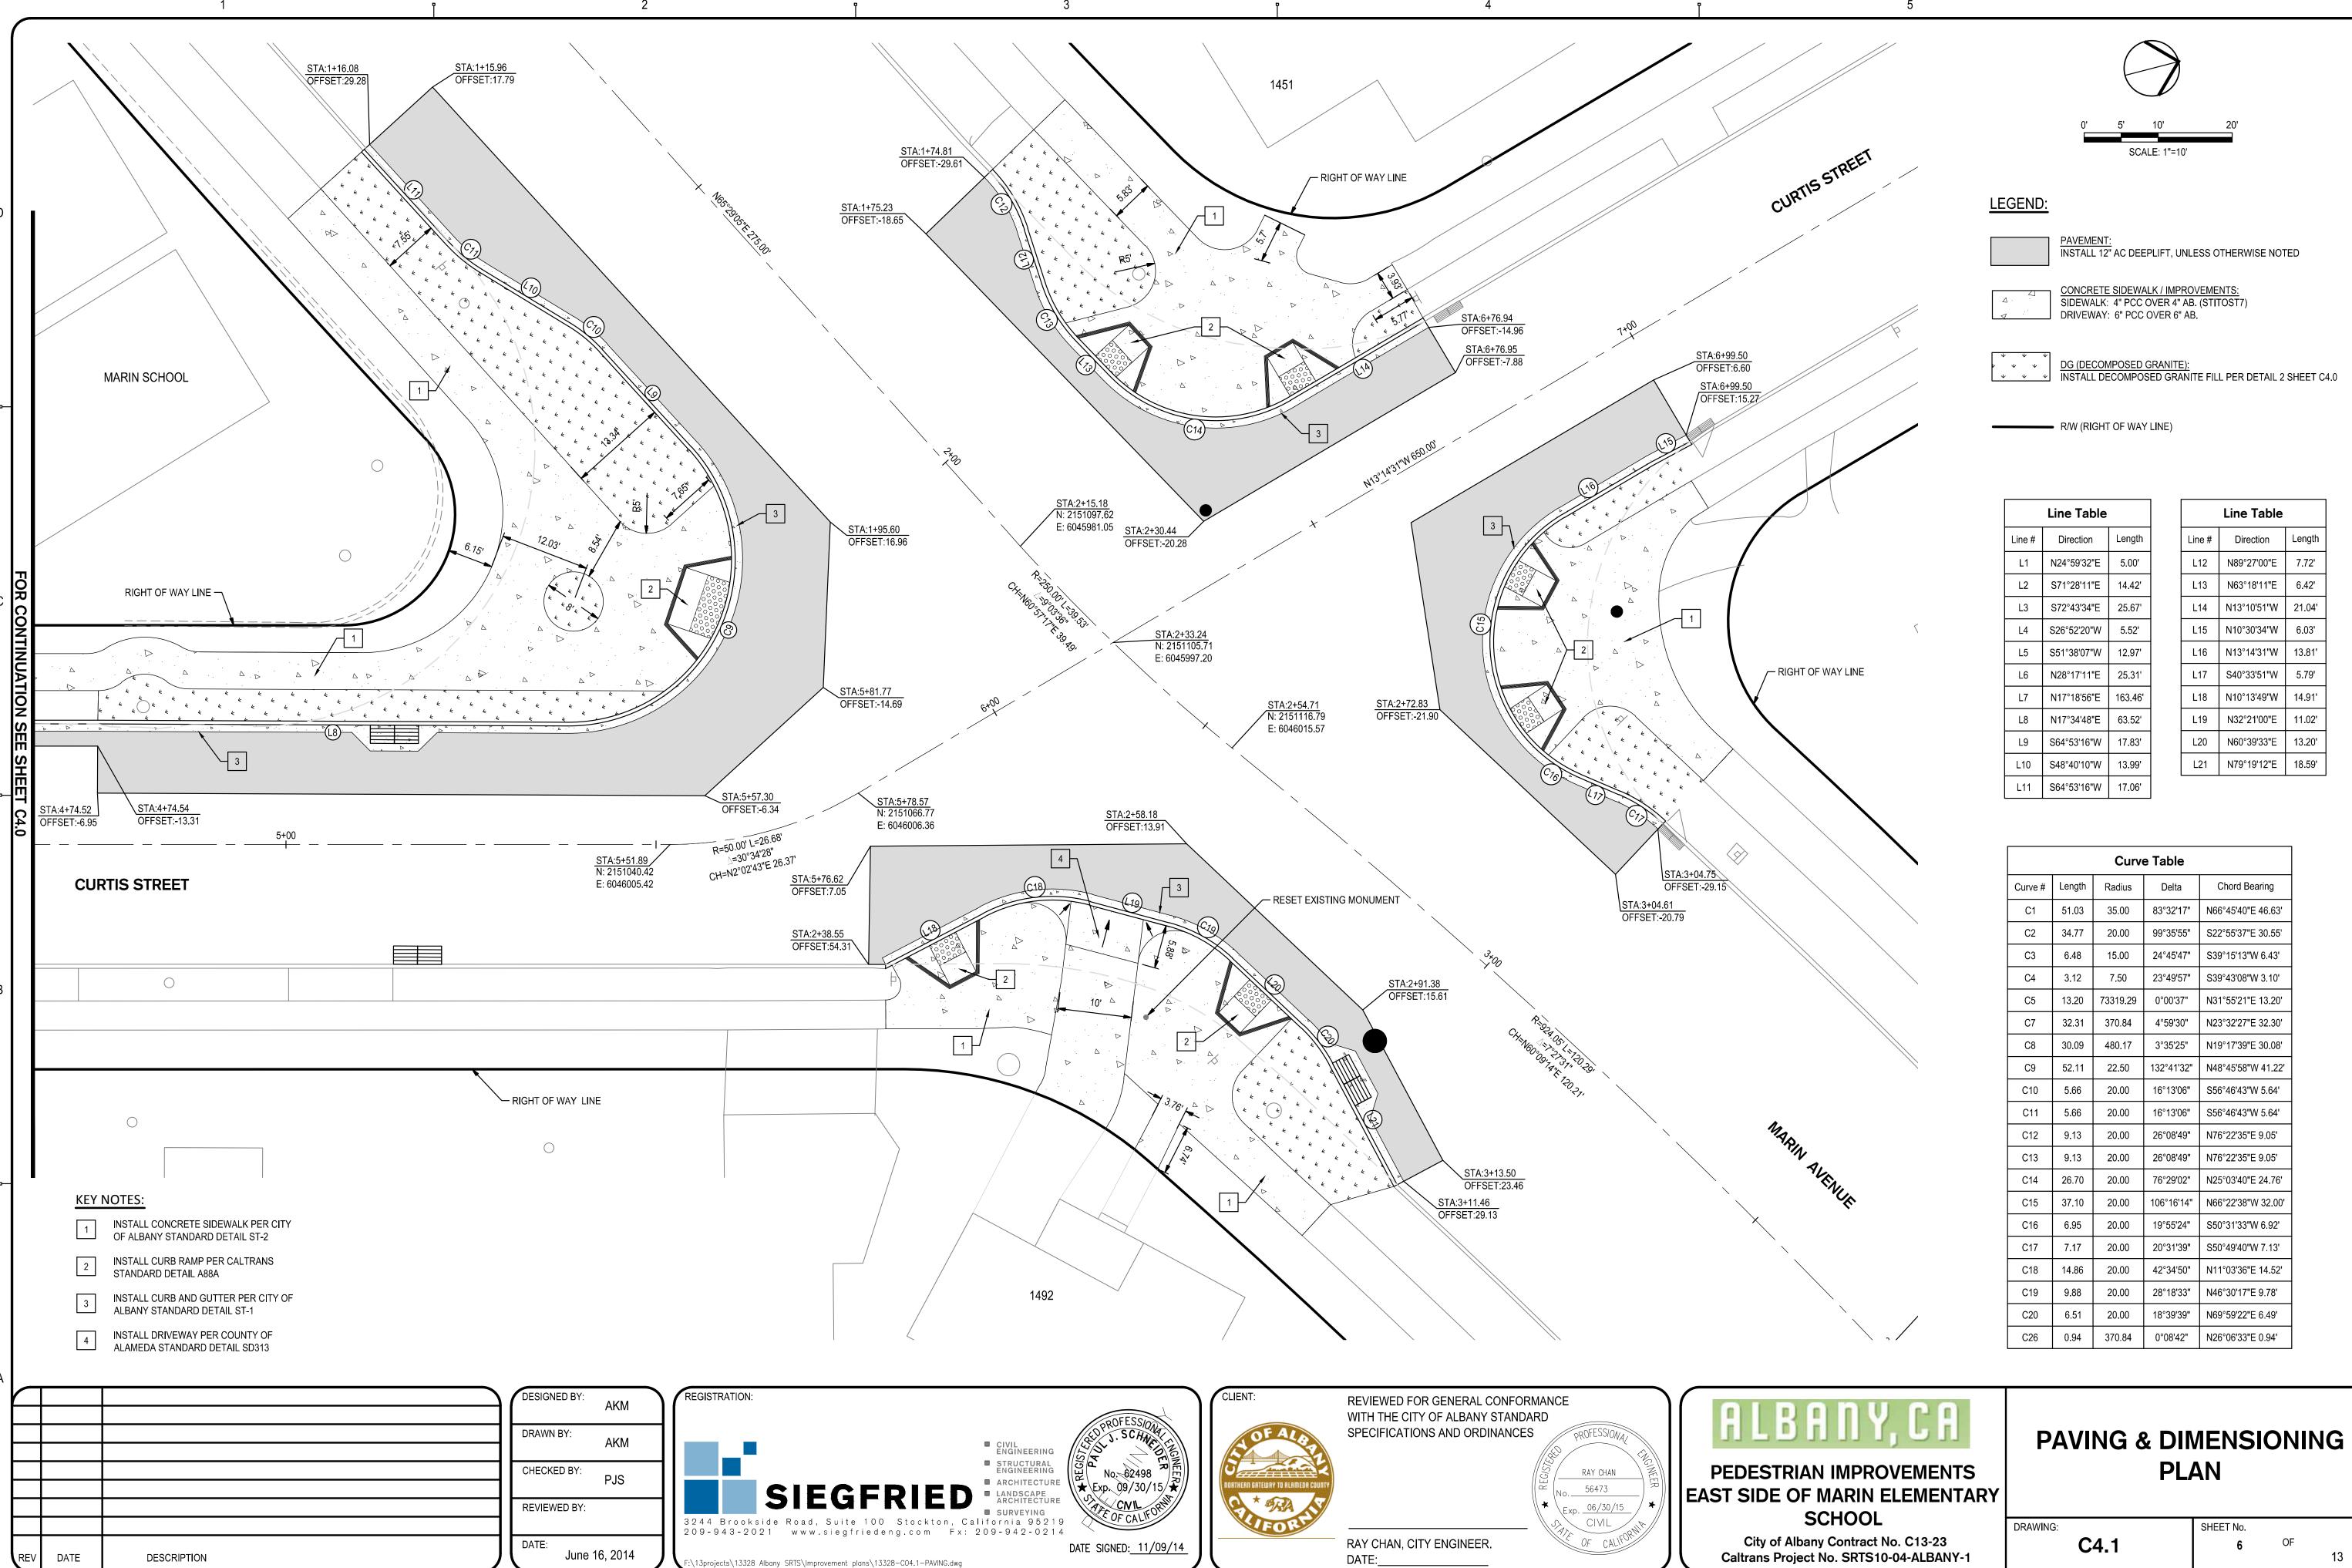
DESCRIPTION

DESIGN DOCUMENTS

Caltrans Project No. SRTS10-04-ALBANY-1


C3.1








DESIGN DOCUMENTS 100%

OF

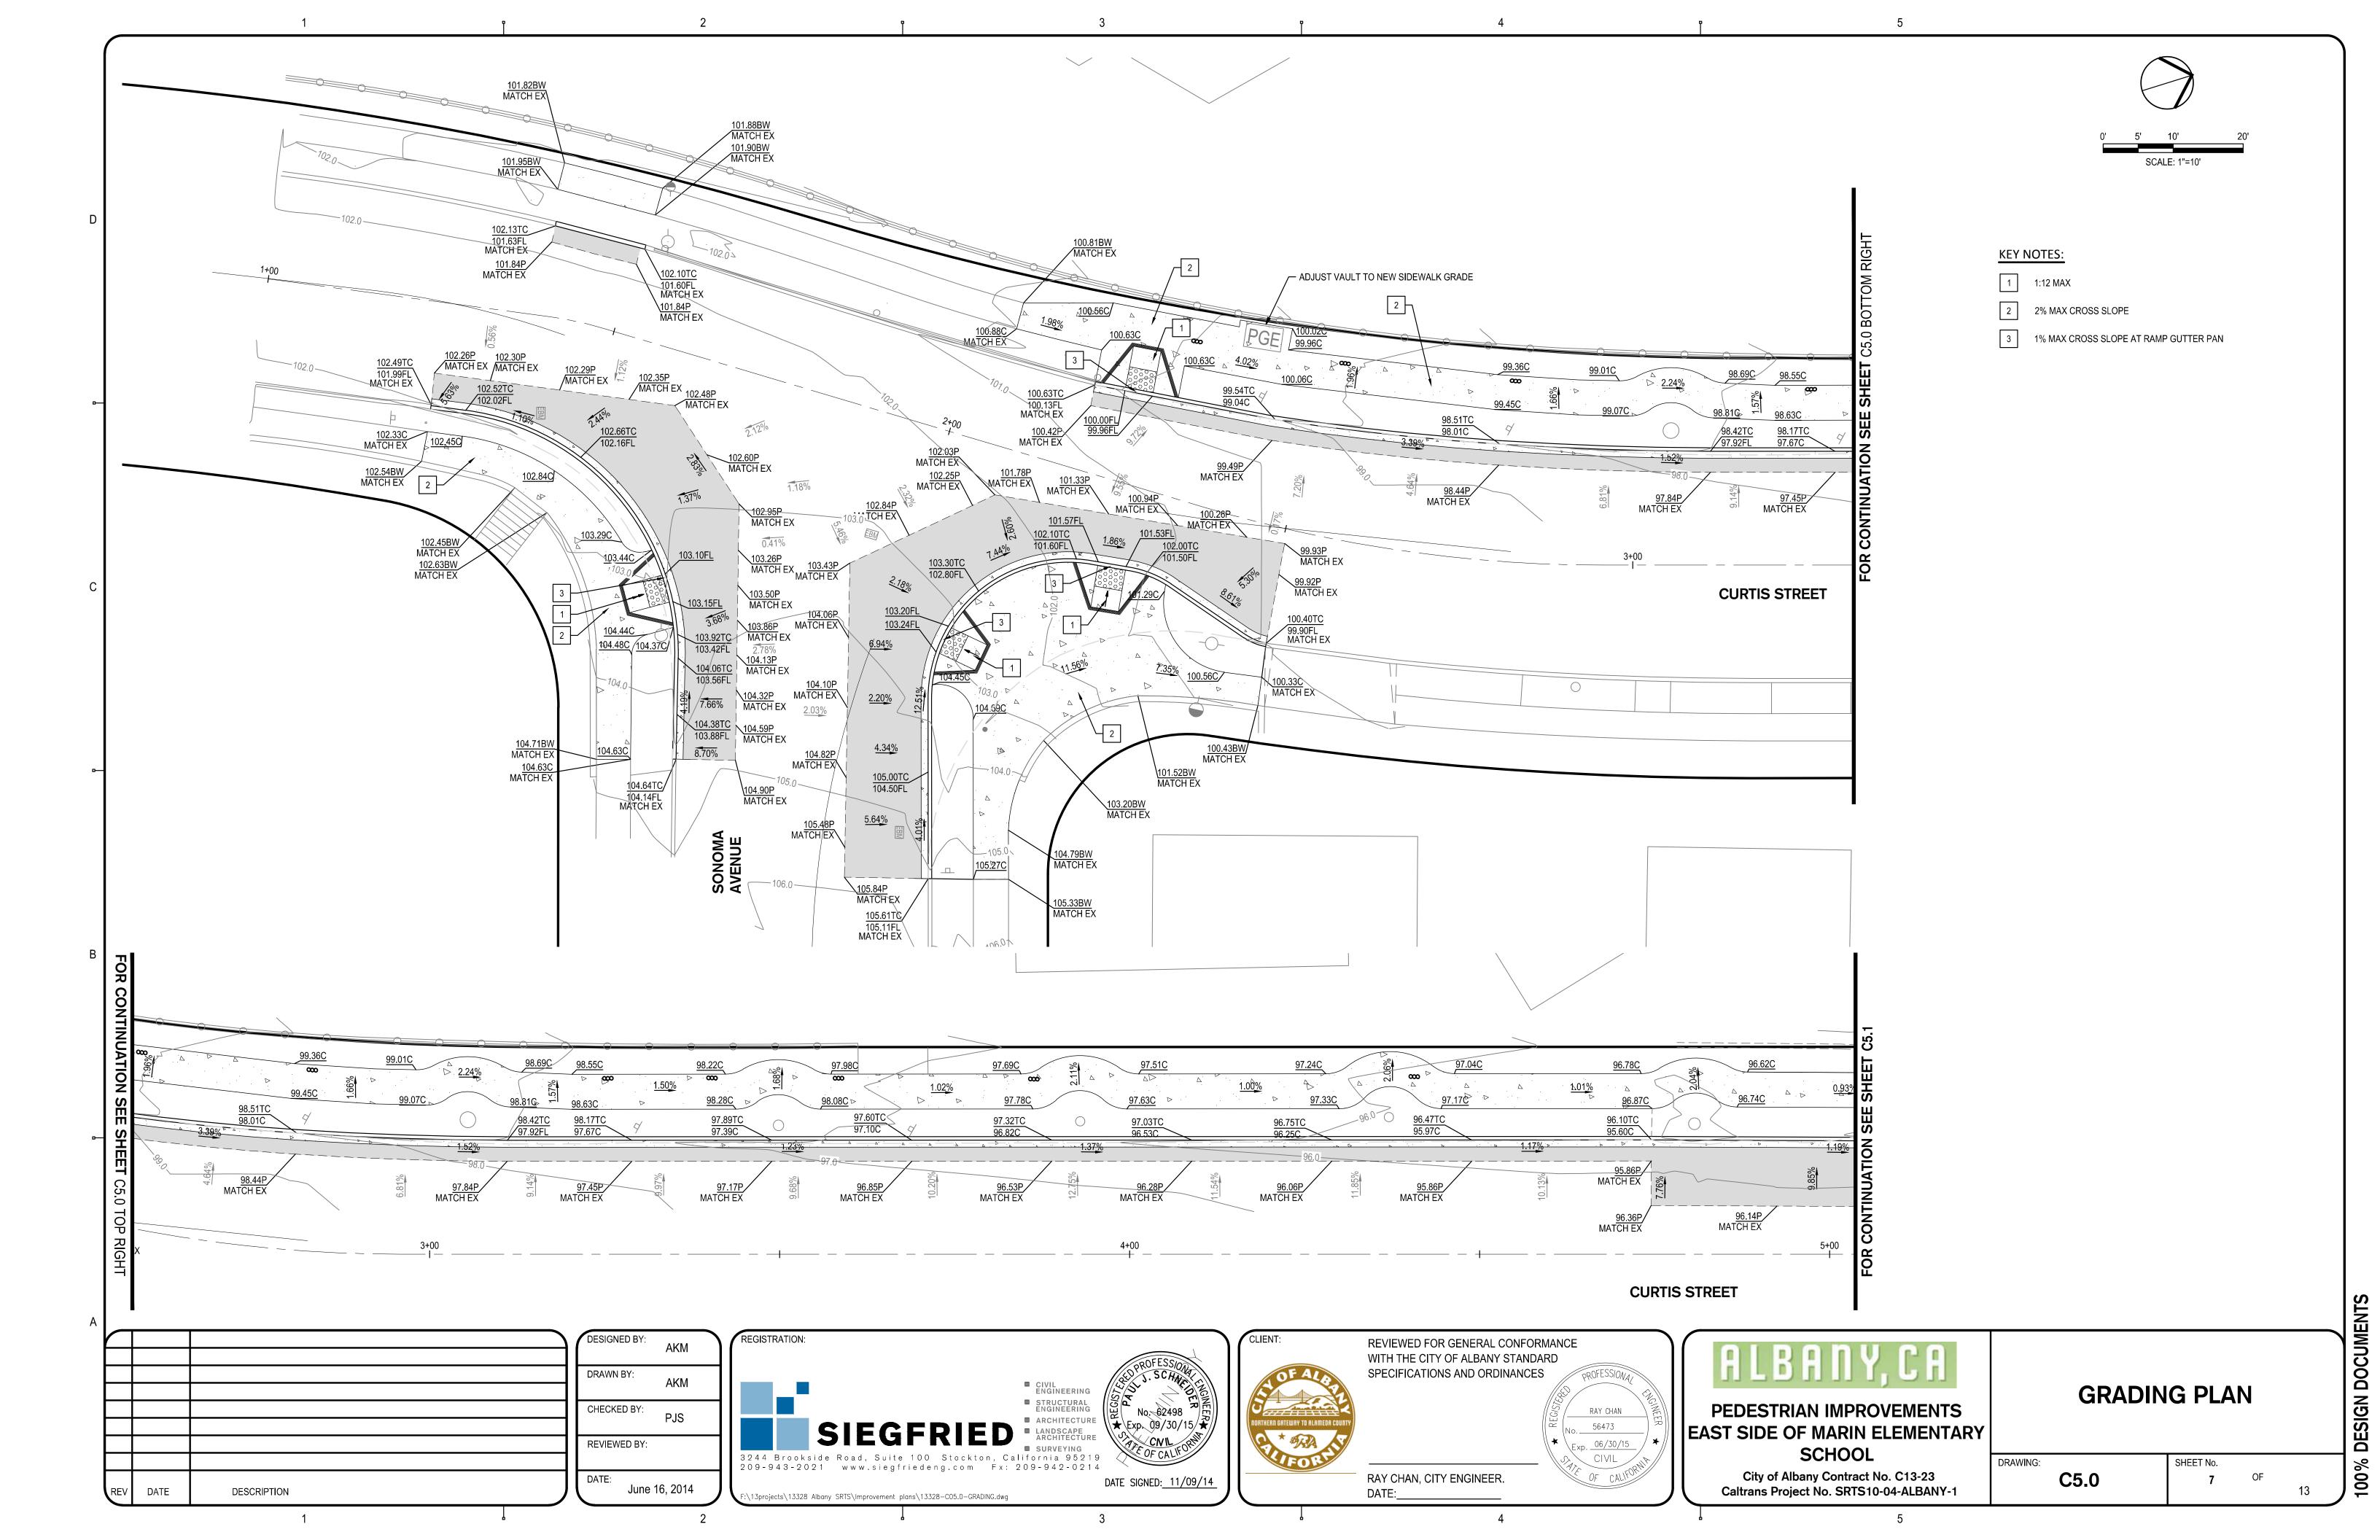

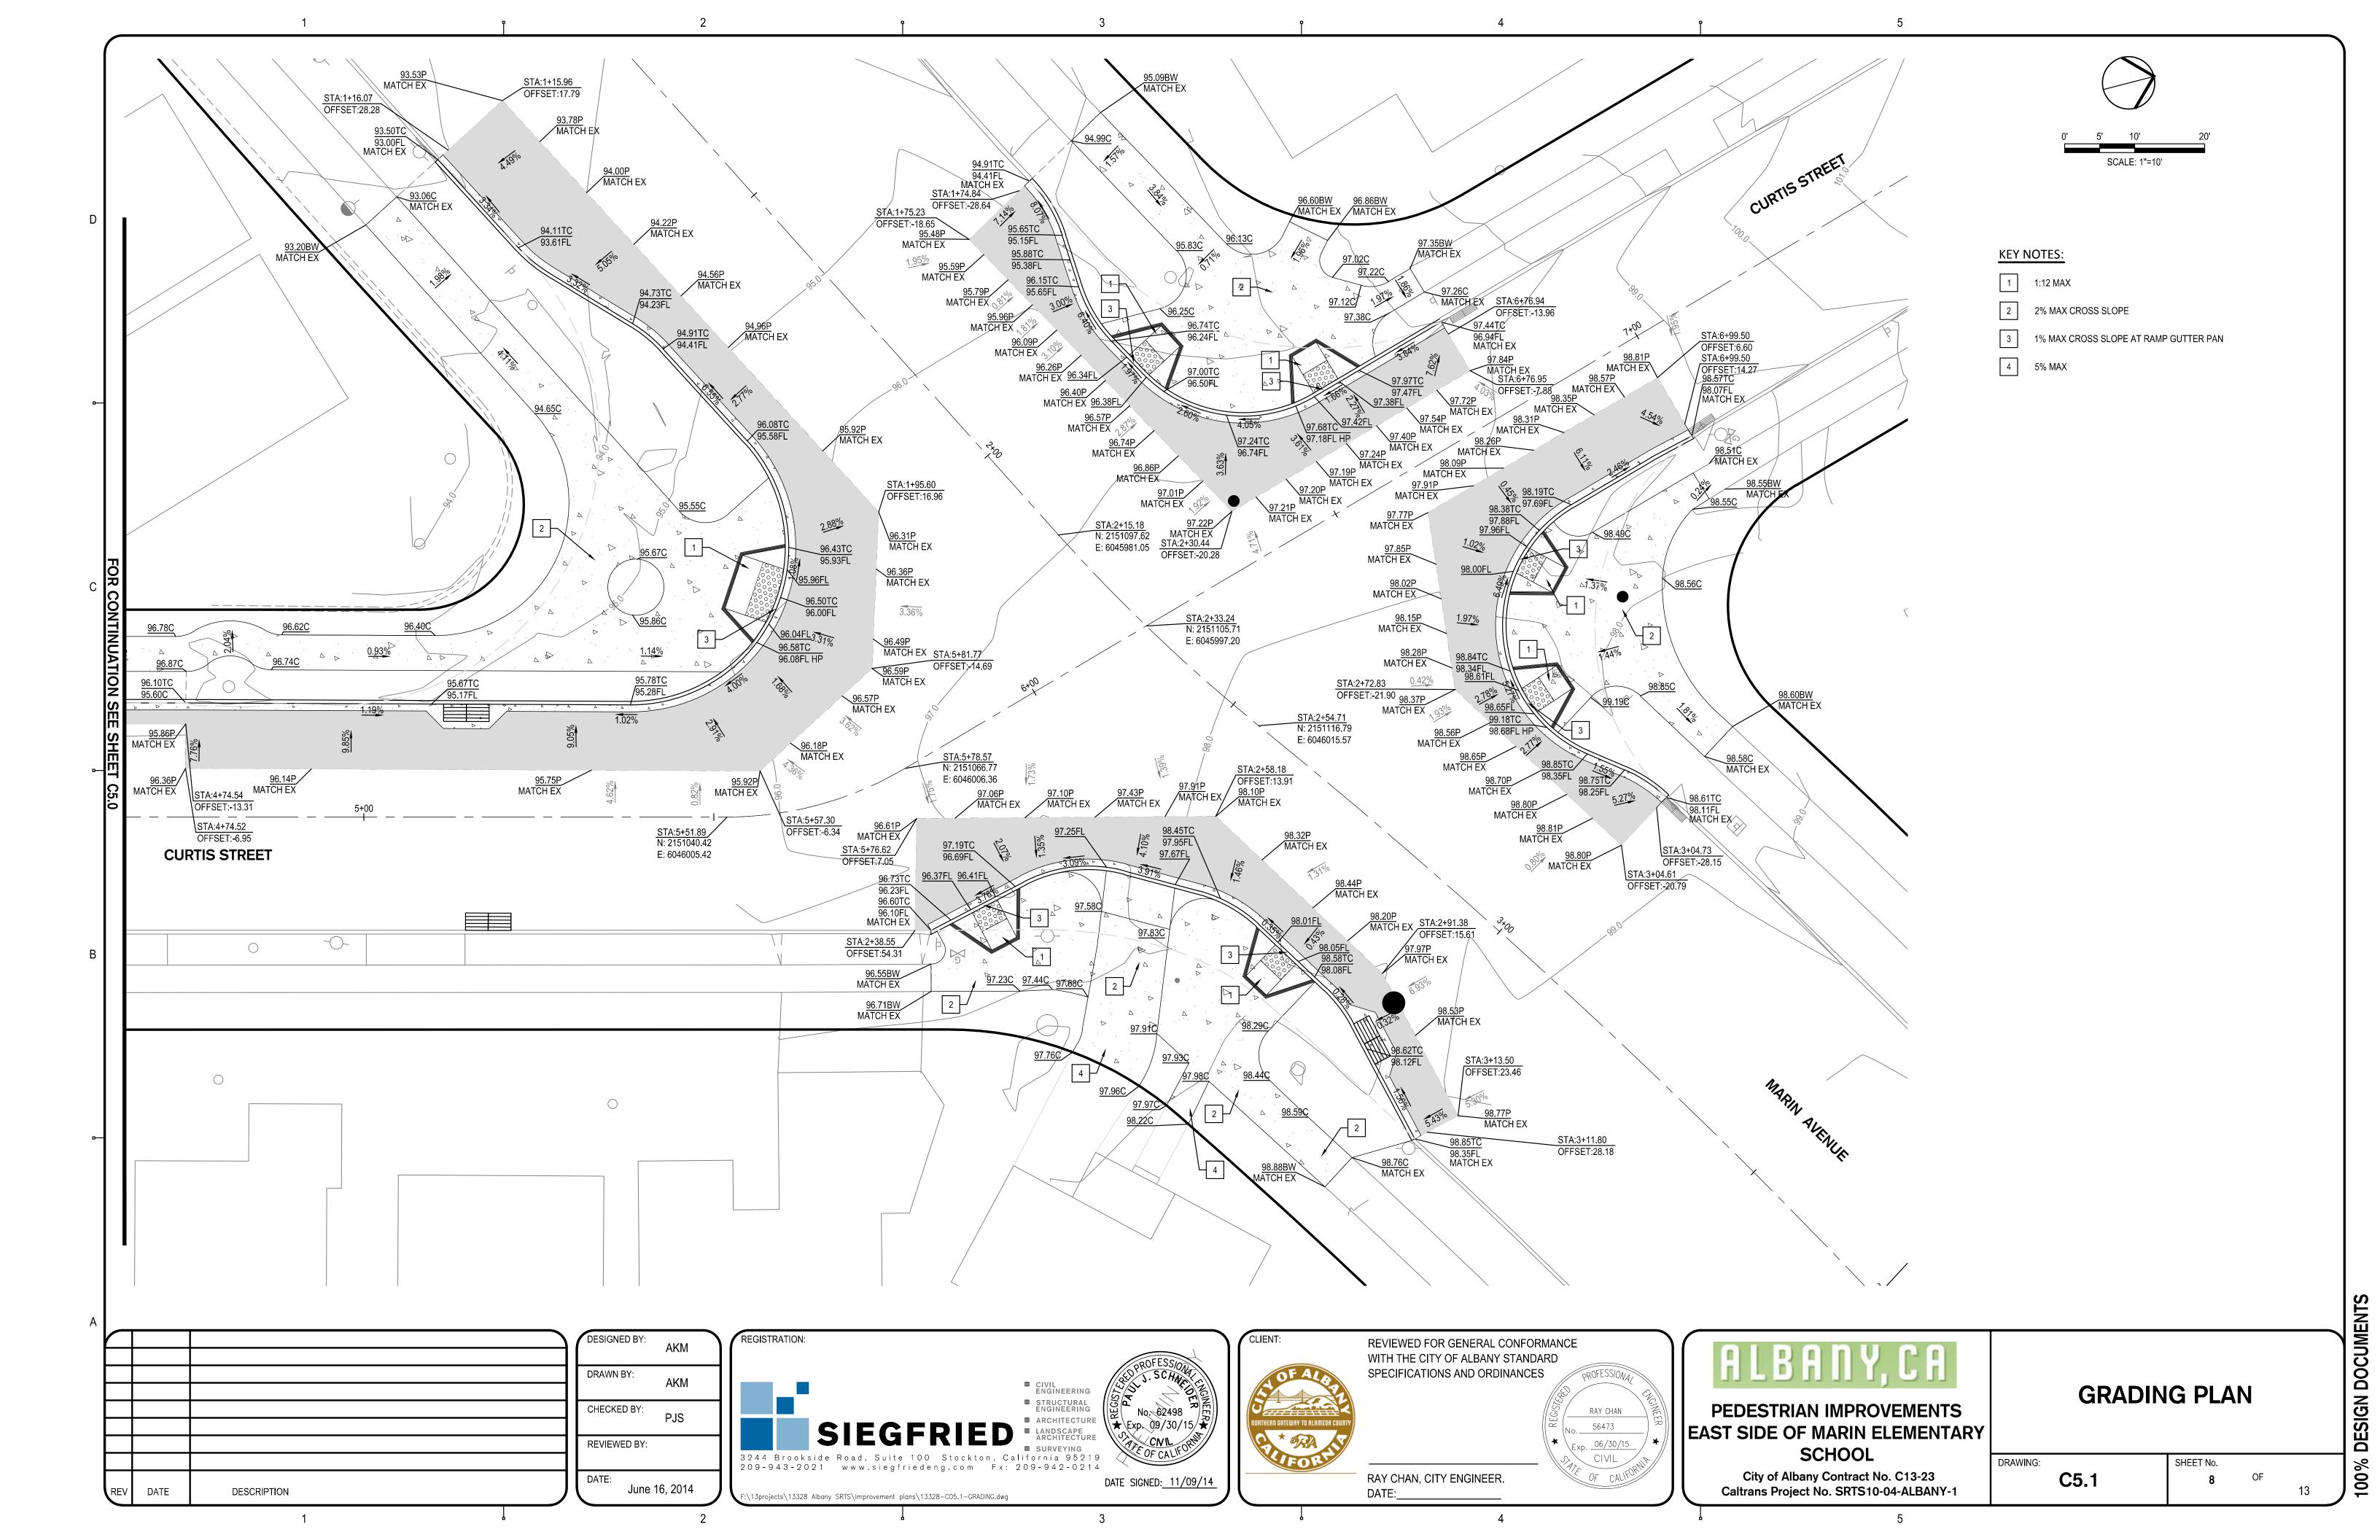

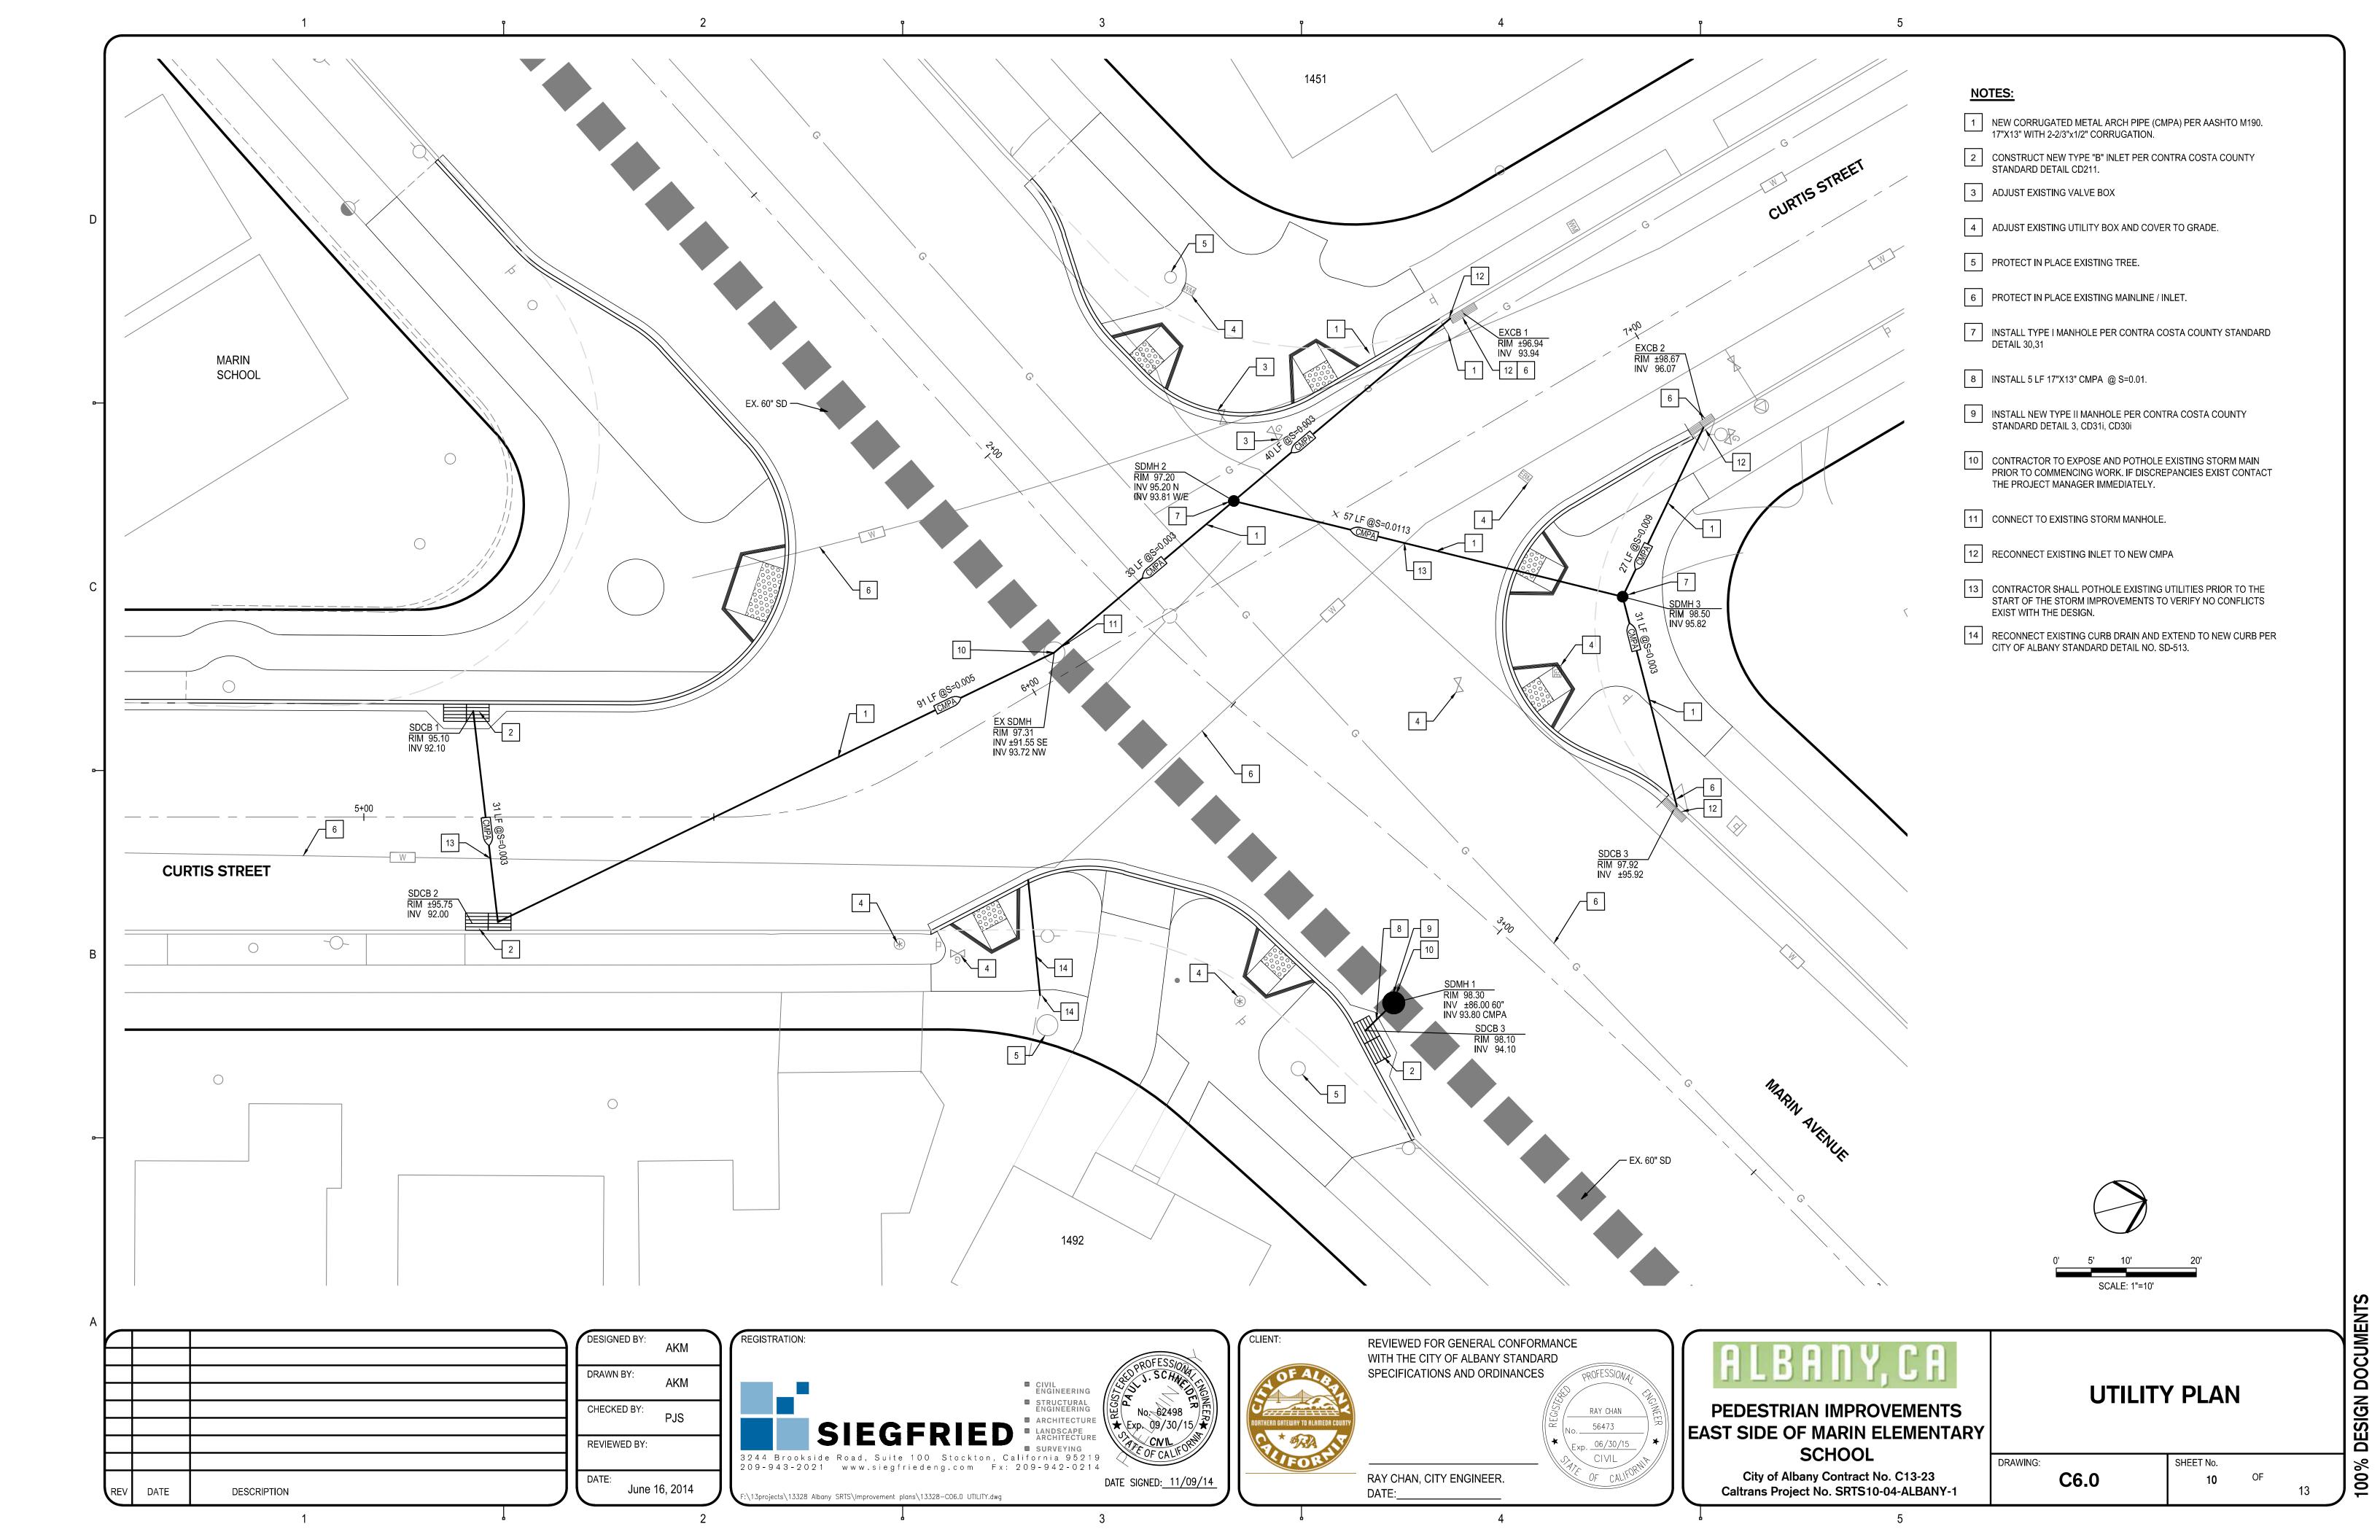

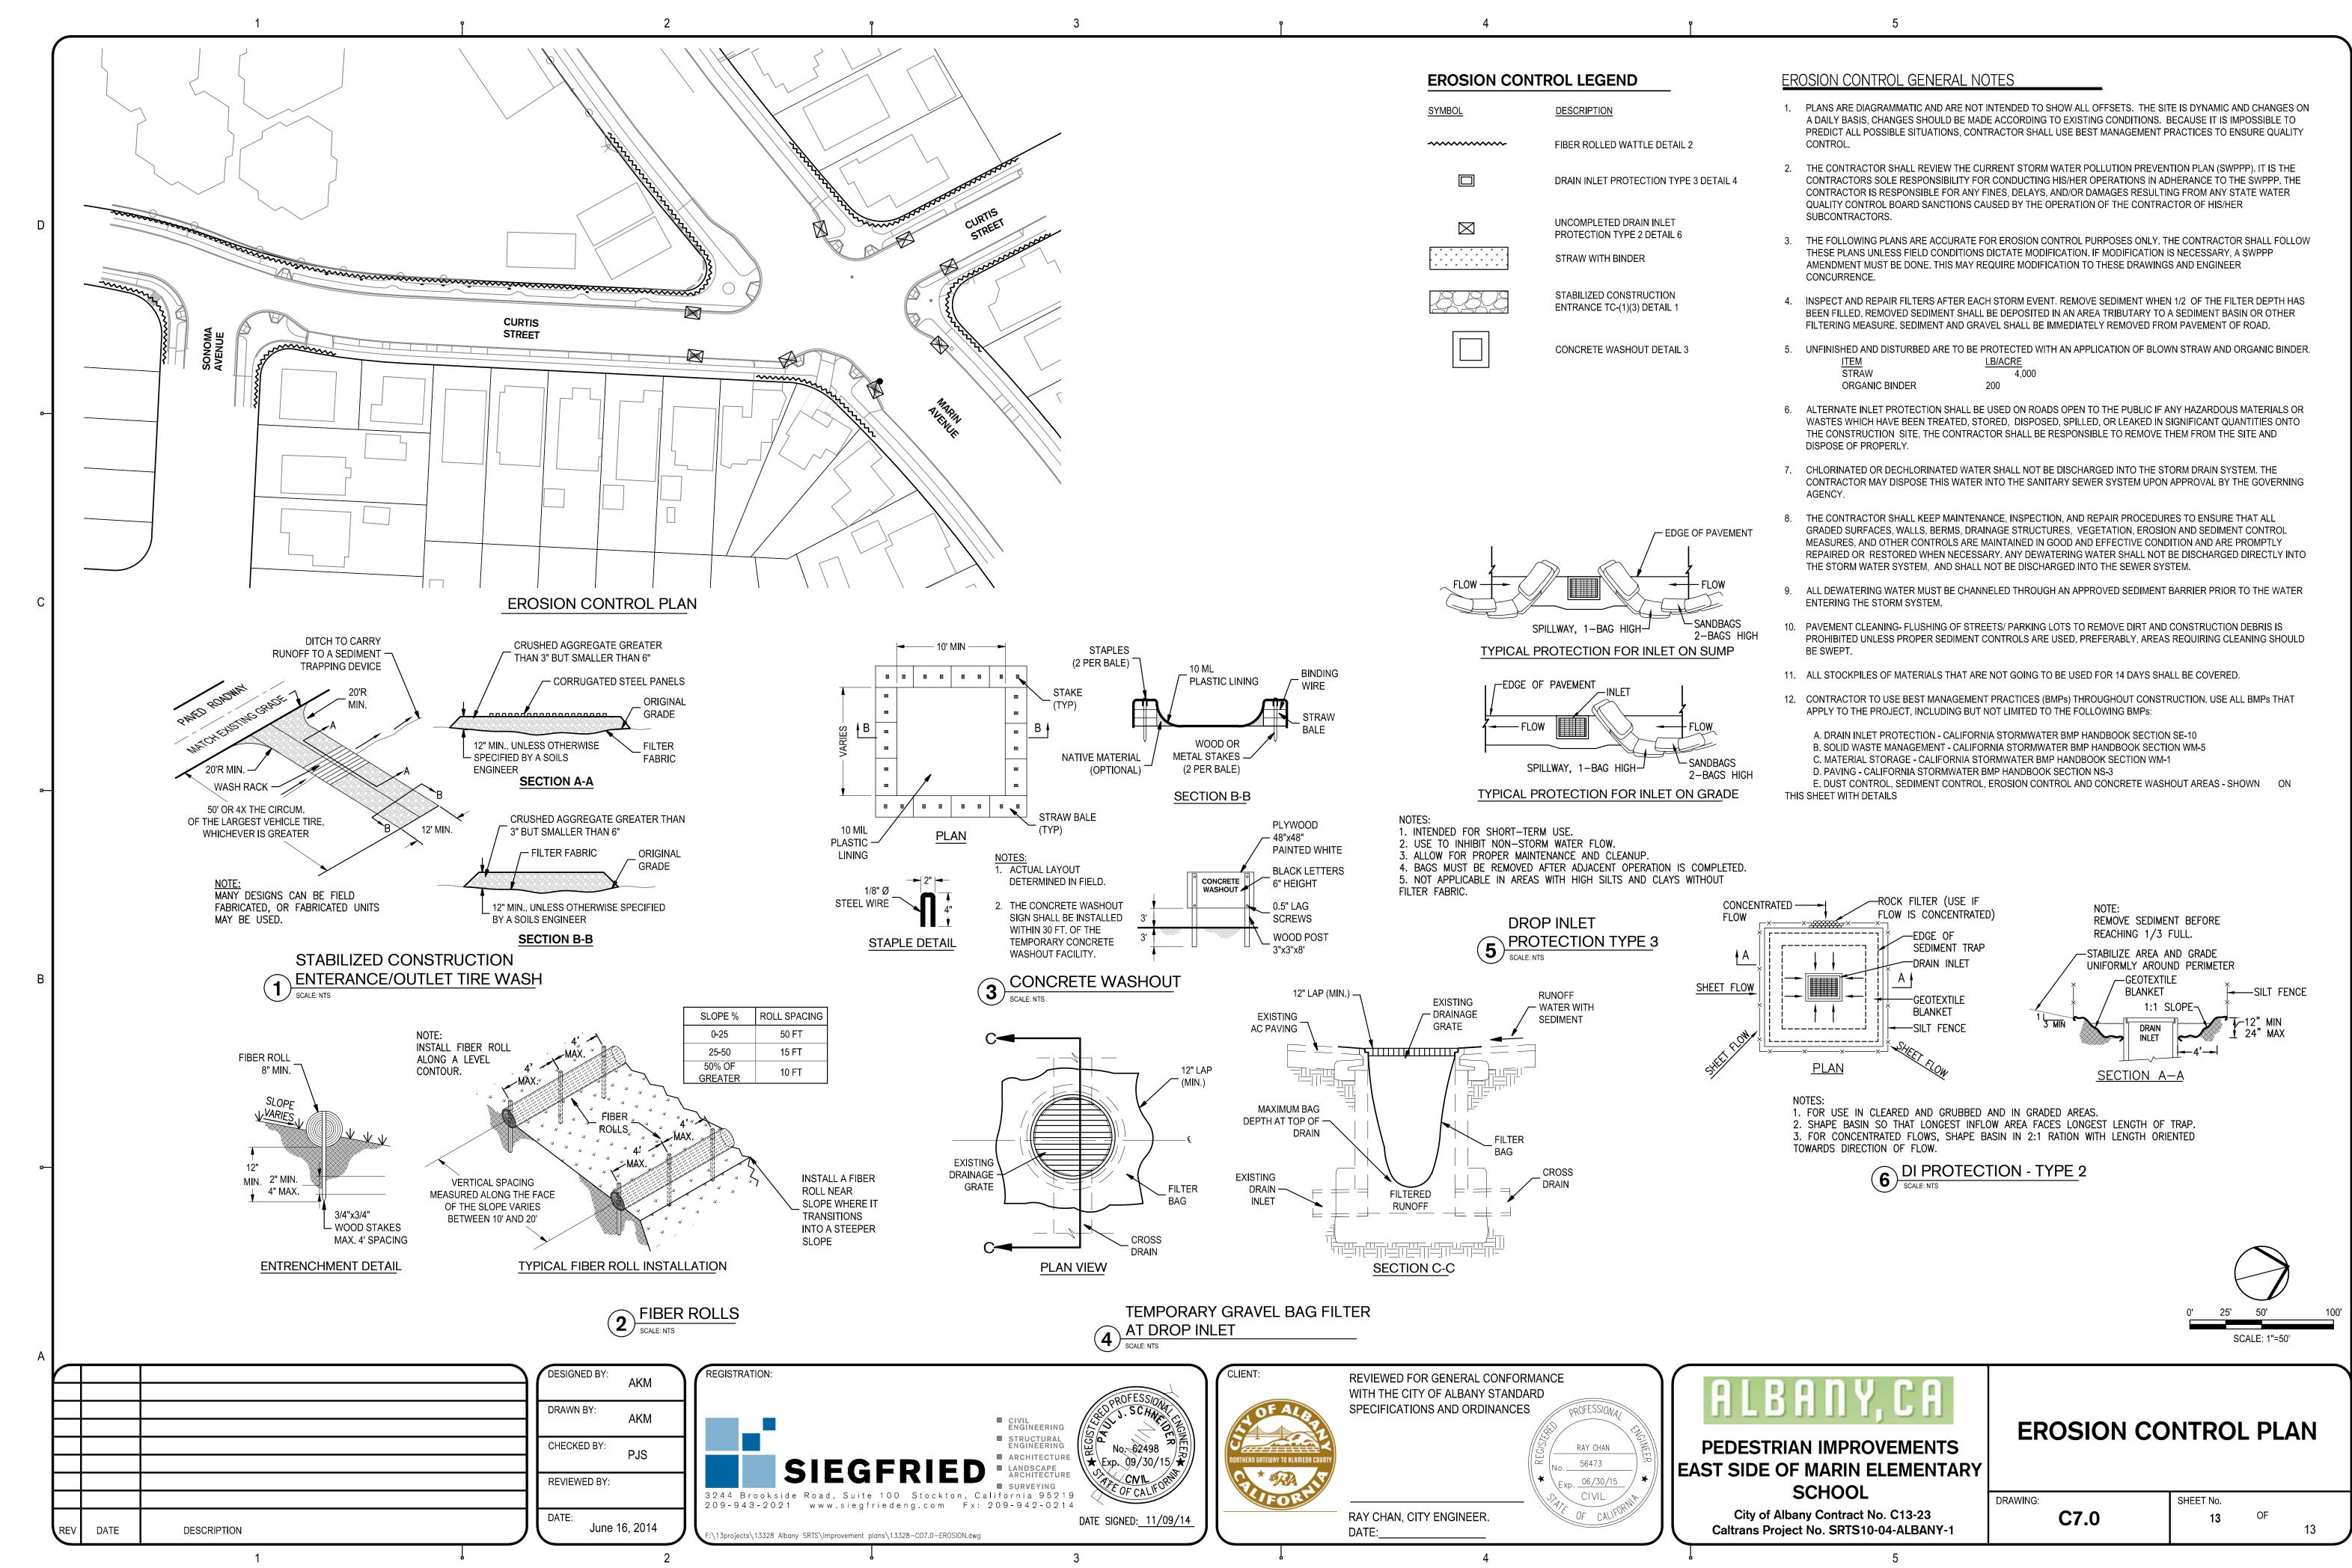

100% DESIGN DOCUMENTS

GENERAL NOTES: (PD-01 & PD-02)

- 1. ALL STRIPING AND PAVEMENT MARKING SHALL BE THERMOPLASTIC, UNLESS OTHERWISE NOTED.
- 2. REMOVE EXISTING STRIPING WHERE IN CONFLICT WITH PROPOSED STRIPING.
- 3. LOCATION AND POSITION OF SIGNS SHALL BE MARKED, VERIFIED AND APPROVED BY THE ENGINEER PRIOR TO INSTALLATION.
- 4. STRIPING DETAILS AND PAVEMENT MARKING DIMENSIONS SHALL BE PER CALTRANS STANDARD PLANS A20A-A20D AND A24A-A24E.
- 5. THIS PLAN ACCURATE FOR SIGNING AND STRIPING ONLY.
- 6. ADJUST RECTANGULAR FLASHING BEACON SIGN SOLAR PANEL TO FACE SOUTH AND TILT 55 DEGREES ZENITH OR AS DIRECTED BY THE ENGINEER. HEIGHT OF SOLAR PANEL SHALL BE AS RECOMMENDED BY MANUFACTURER OR AS DIRECTED BY THE ENGINEER.
- 7. APPLY SEAL COAT ON ALL GRINDED AREAS PRIOR TO PLACING PERMANENT STRIPING AND MARKINGS.

CONSTRUCTION NOTES: (THIS SHEET ONLY)

- FURNISH AND INSTALL DUAL LIGHTBAR RAPID FLASHING RECTANGULAR BEACON WITH S1-1 AND W16-7p SIGNS AND ADA PUSHBUTTON ON 1-B POLE.
- 2 INSTALL 11' O.C. YELLOW CROSSWALK. OUTER EDGES SHALL BE 12", TRANSVERSE MARKINGS SHALL BE 12" SPACED 3' O.C.
- 3 INSTALL 12" WHITE LIMIT LINE.
- 4 REMOVE EXISTING PAVEMENT STRIPE.
- 5 INSTALL DETAIL 40.
- 6 PAINT CURB RED


LEGEND:

- SOLAR POWERED RECTANGULAR RAPID FLASH BEACON SIGN
- ROADSIDE SIGN ON METAL POLE
- $\langle \# \rangle$ proposed caltrans pavement delineation detail number
- (#) EXISTING CALTRANS PAVEMENT DELINEATION DETAIL NUMBER
- EXISTING ROADSIDE SIGN ON METAL POLE


S→ → BIKE LANE SYMBOL

YVVVV YIELD MARKING

SHARED LANE MARKING

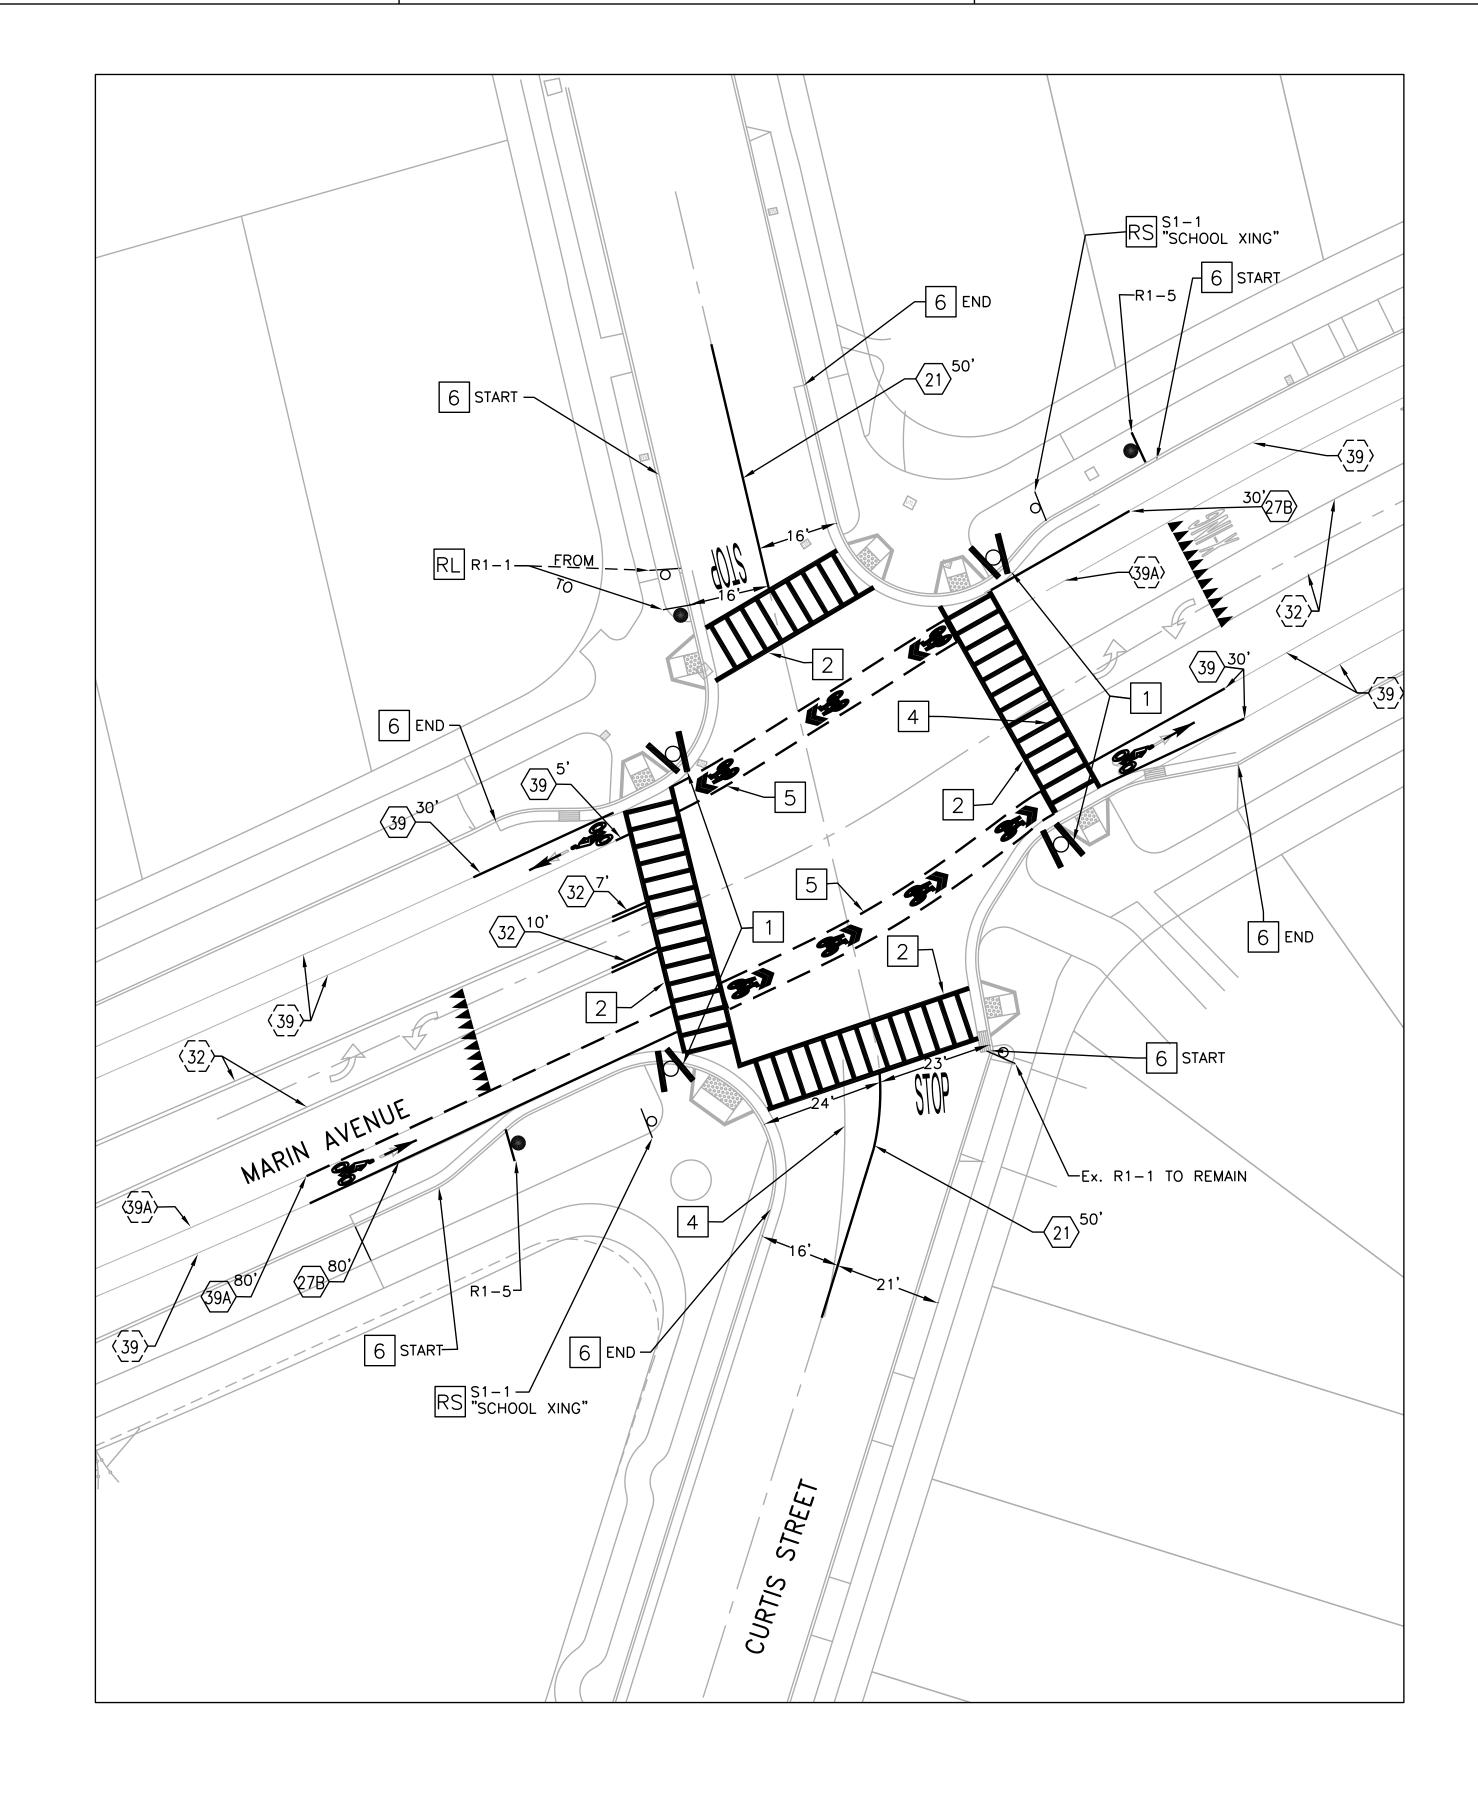

99% SUBMITTAL NOT FOR CONSTRUCTION

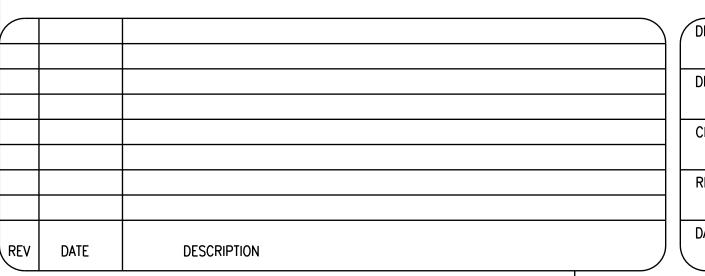

DESIGNED BY:

RP

DRAWN BY:

RP

CHECKED BY:


AP

REVIEWED BY:


AP

DATE:

June 17, 2014

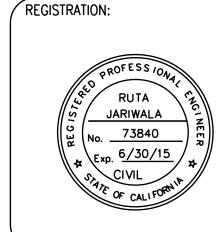



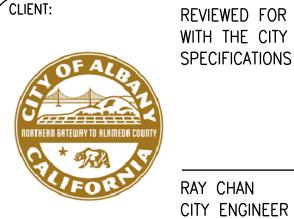

REVIEWED FOR GENERAL CONFORMANCE
WITH THE CITY OF ALBANY STANDARD
SPECIFICATIONS AND ORDINANCES

RAY CHAN

RAY CHAN

RAY CHAN

RAY CHAN

RAY CHAN

RAY CHAN

ALBANY, CA

Marin Avenue/Curtis Street
Safety Improvements
City of Albany Contract No. 14-12
Caltrans Project No. SR2SL-5178(014)

PAVEMENT DELINEATION
AND SIGNAGE PLAN
MARIN AVE / CURTIS ST

PD-01

SHEET No.
OF
3

SCALE: 1"=20'


CONSTRUCTION NOTES: (THIS SHEET ONLY)

- 1 INSTALL 11' O.C. YELLOW CROSSWALK. OUTER EDGES SHALL BE 12", TRANSVERSE MARKINGS SHALL BE 12" SPACED 3' O.C.
- 2 INSTALL 12" WHITE LIMIT LINE.
- 3 REMOVE EXISTING PAVEMENT STRIPE.
- 4 PAINT CURB RED

LEGEND:

SOLAR POWERED RECTANGULAR RAPID FLASH BEACON SIGN

- ROADSIDE SIGN ON METAL POLE
- PROPOSED CALTRANS PAVEMENT DELINEATION DETAIL NUMBER
- EXISTING ROADSIDE SIGN ON METAL POLE

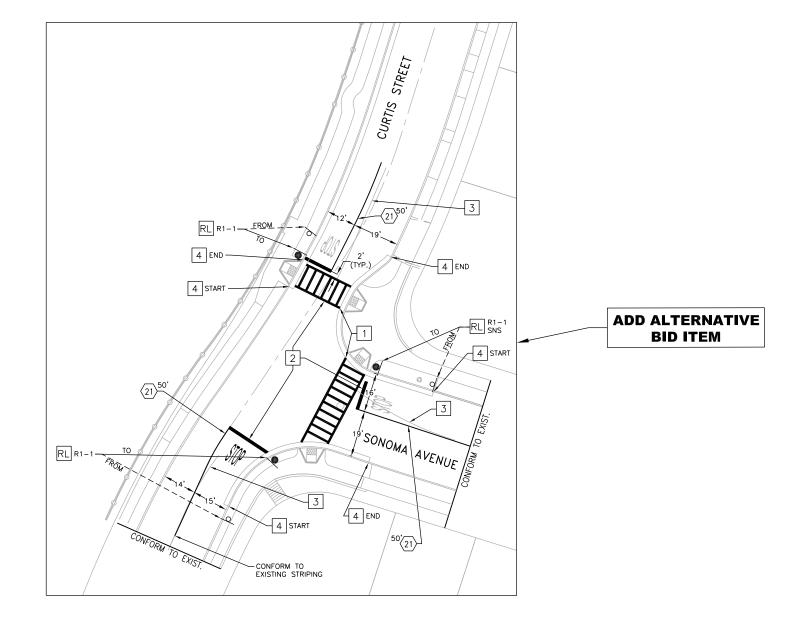


95% SUBMITTAL **NOT FOR CONSTRUCTION**





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ALBANY, CA

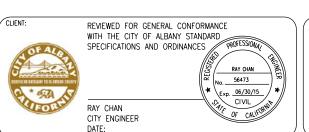Marin Avenue/Curtis Street Safe Routes to School City of Albany Contract No. 14-12 Caltrans Project No. SR2SL-5178(014)

PAVEMENT DELINEATION AND SIGNAGE PLAN CURTIS ST / SONOMA AVE

SCALE: 1"=20'

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